## FINAL LAND DEVELOPMENT PLANS FOR

# 610 OLD YORK ROAD

SITUATED IN:


JENKINTOWN BOROUGH MONTGOMERY COUNTY, PENNSYLVANIA


PREPARED FOR:

SBG MANAGEMENT SERVICES, INC.

P.O. BOX 549

ABINGTON, PENNSYLVANIA 19001

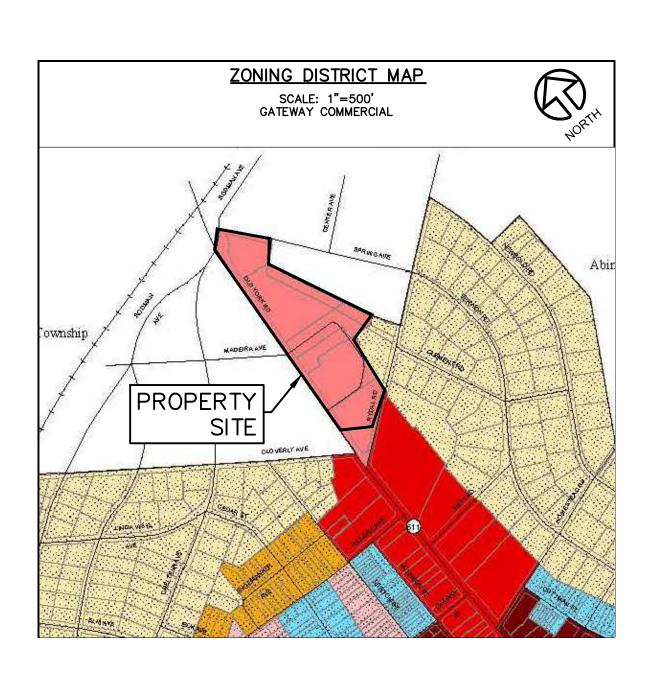

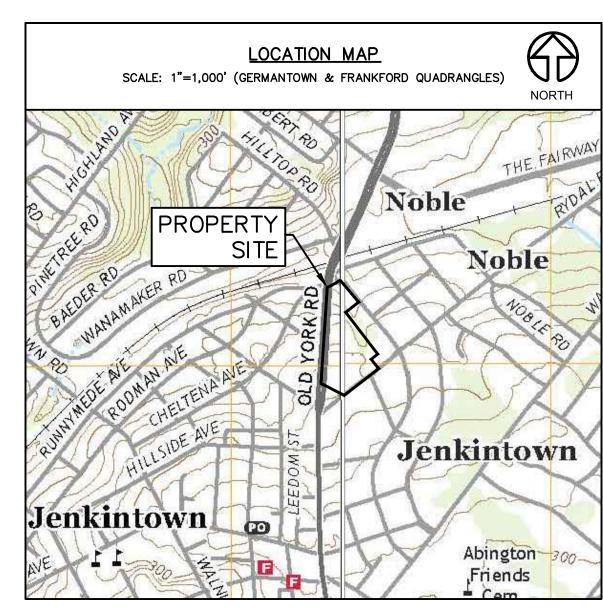



DESIGN ONE CALL SERIA	L NO(s): 20210291778 20210291779
COMCAST ROBERT HARVERY BOB_HARVEY@CABLE.COMCAST.COM 4400 WAYNE AVE PHILADELPHIA, PA 19140	AQUA PENNSYLVANIA INC STEVE PIZZI SBPIZZI@AQUAAMERICA,COM 762 W LANCASTER AVE BRYN MAWR, PA 19010
PECO ENERGY C/O USIC NIKKIA SIMPKINS NIKKIASIMPKINS@USICLLC.COM 450 S HENDERSON RD SUITE B KING OF PRUSSIA, PA 19406	CENTURY LINK CENTURY LINK OPERATOR PERSONNE NATIONALRELO@CENTURYLINK.COM 1025 ELDORADO BLVD BROOMFIELD, CO.80021
SOUTHEASTERN PA TRANSPORTATION AUTHORITY TYLER LADD TLADD@SEPTA.ORG 1234 MARKET ST 12TH FLOOR PHILADLEPHIA, PA 19107	ABINGTON TOWNSHIP TIM CLARK TCLARK@ABINGTON.ORG 1176 OLD YORK RD ABINGTON, PA 19001
VERIZON PENNSYLVANIA LLC DARLINE LEPPERD JOHNSON 1050 VIRGINIA DR FORT WASHINGTON, PA 19034	CROWN CASTLE TYLER STEIN TYLER.STEIN@CROWNCASTLE.COM 1500 CORPORATE DR CANONSBURG, PA 15317
JENKINTOWN BOROUGH JIM RIGGINS KRIGGINS@JENKINTOWNBORO.COM 700 SUMMIT AVE JENKINTOWN, PA 19046	
PA ONE CALL SYSTEM	M 1-800-242-1776
LOCATIONS OF EXISTING UTILITIES SHOWN EXISTING RECORDS AND/OR ABOVE—GROWPLETENESS OR ACCURACY OF LOCA CONTRACTORS AND OTHER PERSONS UTILICONTAINED HEREON ARE CAUTIONED TO	ROUND OBSERVATIONS AT THE SITE. TION CANNOT BE GUARANTEED. ALL ZING THIS PLAN AND THE INFORMATION

	311661	LIST THULL
SHEET NUMBER	SHEET DESCRIPTION	SHEET TITLE
1	G-101	COVER SHEET
2	C-101	RECORD PLAN (R)
3	V-101	EXISTING FEATURES & DEMOLITION PLAN & ERSAM MAP
4	V-102	OVERALL EXISTING FEATURES PLAN
5	C-102	GRADING & UTILITY PLAN
6	CJ-101	EROSION & SEDIMENTATION CONTROL PLAN
7	CJ-501	EROSION AND SEDIMENTATION CONTROL NOTES
8	CJ-502	EROSION & SEDIMENTATION CONTROL DETAILS
9	C-501	CONSTRUCTION DETAILS
10	C-502	CONSTRUCTION DETAILS (2)
11	C-503	CONSTRUCTION DETAILS (3)
12	C-103	STORM SEWER PROFILES
13	LL-101	LANDSCAPE PLAN
14	LL-102	LIGHTING PLAN
15	C-104	TRUCK TURNING PLAN
16	C-105	EASEMENT PLAN (R)
(R) - TO BE RECORDED		

SHFFT LIST TABLE

BOROUGH ENGINEER CERTIFICATION

REVIEWED BY: THE JENKINTOWN BOROUGH ENGINEER ON THE \_\_\_\_ DAY OF \_\_\_\_, 20\_\_.

BOROUGH ENGINEER, P.E.

# Carroll Engineering Corporation



949 Easton Road Warrington, PA 18976 Phone: 215-343-5700 Fax: 215-343-0875

630 Freedom Business Center, Third Floor 105 Raider Boulevard, Suite 206 101 Lindenwood Drive, Suite 225 102 Larry Holmes Drive, Suite 201 King of Prussia, PA 19406 Phone: 610-489-5100

Fax: 610-489-2674

Hillsborough, NJ 08844 Phone: 908-874-7500 Fax: 908-874-5762

Malvern, PA 19355 Phone: 484-875-3075 Fax: 484-875-3178


PENNSYLVANIA ACT 287, AS AMENDED, TITLED "EXCAVATION AND DEMOLITION WORK PROTECTION OF UNDERGROUND UTILITIES." EACH INDIVIDUAL USING THIS PLAN MUST VERIFY THE DEPTH AND LOCATION OF ALL UNDERGROUND FACILITIES BEFORE

> Easton, PA 18042 Phone: 610-989-4940

APPLICANT
SBG MANAGEMENT SERVICES, INC. ABINGTON, PA 19001 215-938-6665 PHIL@SBGMANAGEMENT.COM


DEED BOOK AND PAGE: 6024-00428 JENKINS COURT REALTY COMPANY LP PO BOX 549 ABINGTON, PENNSYLVANIA 19001 215-938-6665 PHIL@SBGMANAGEMENT.COM


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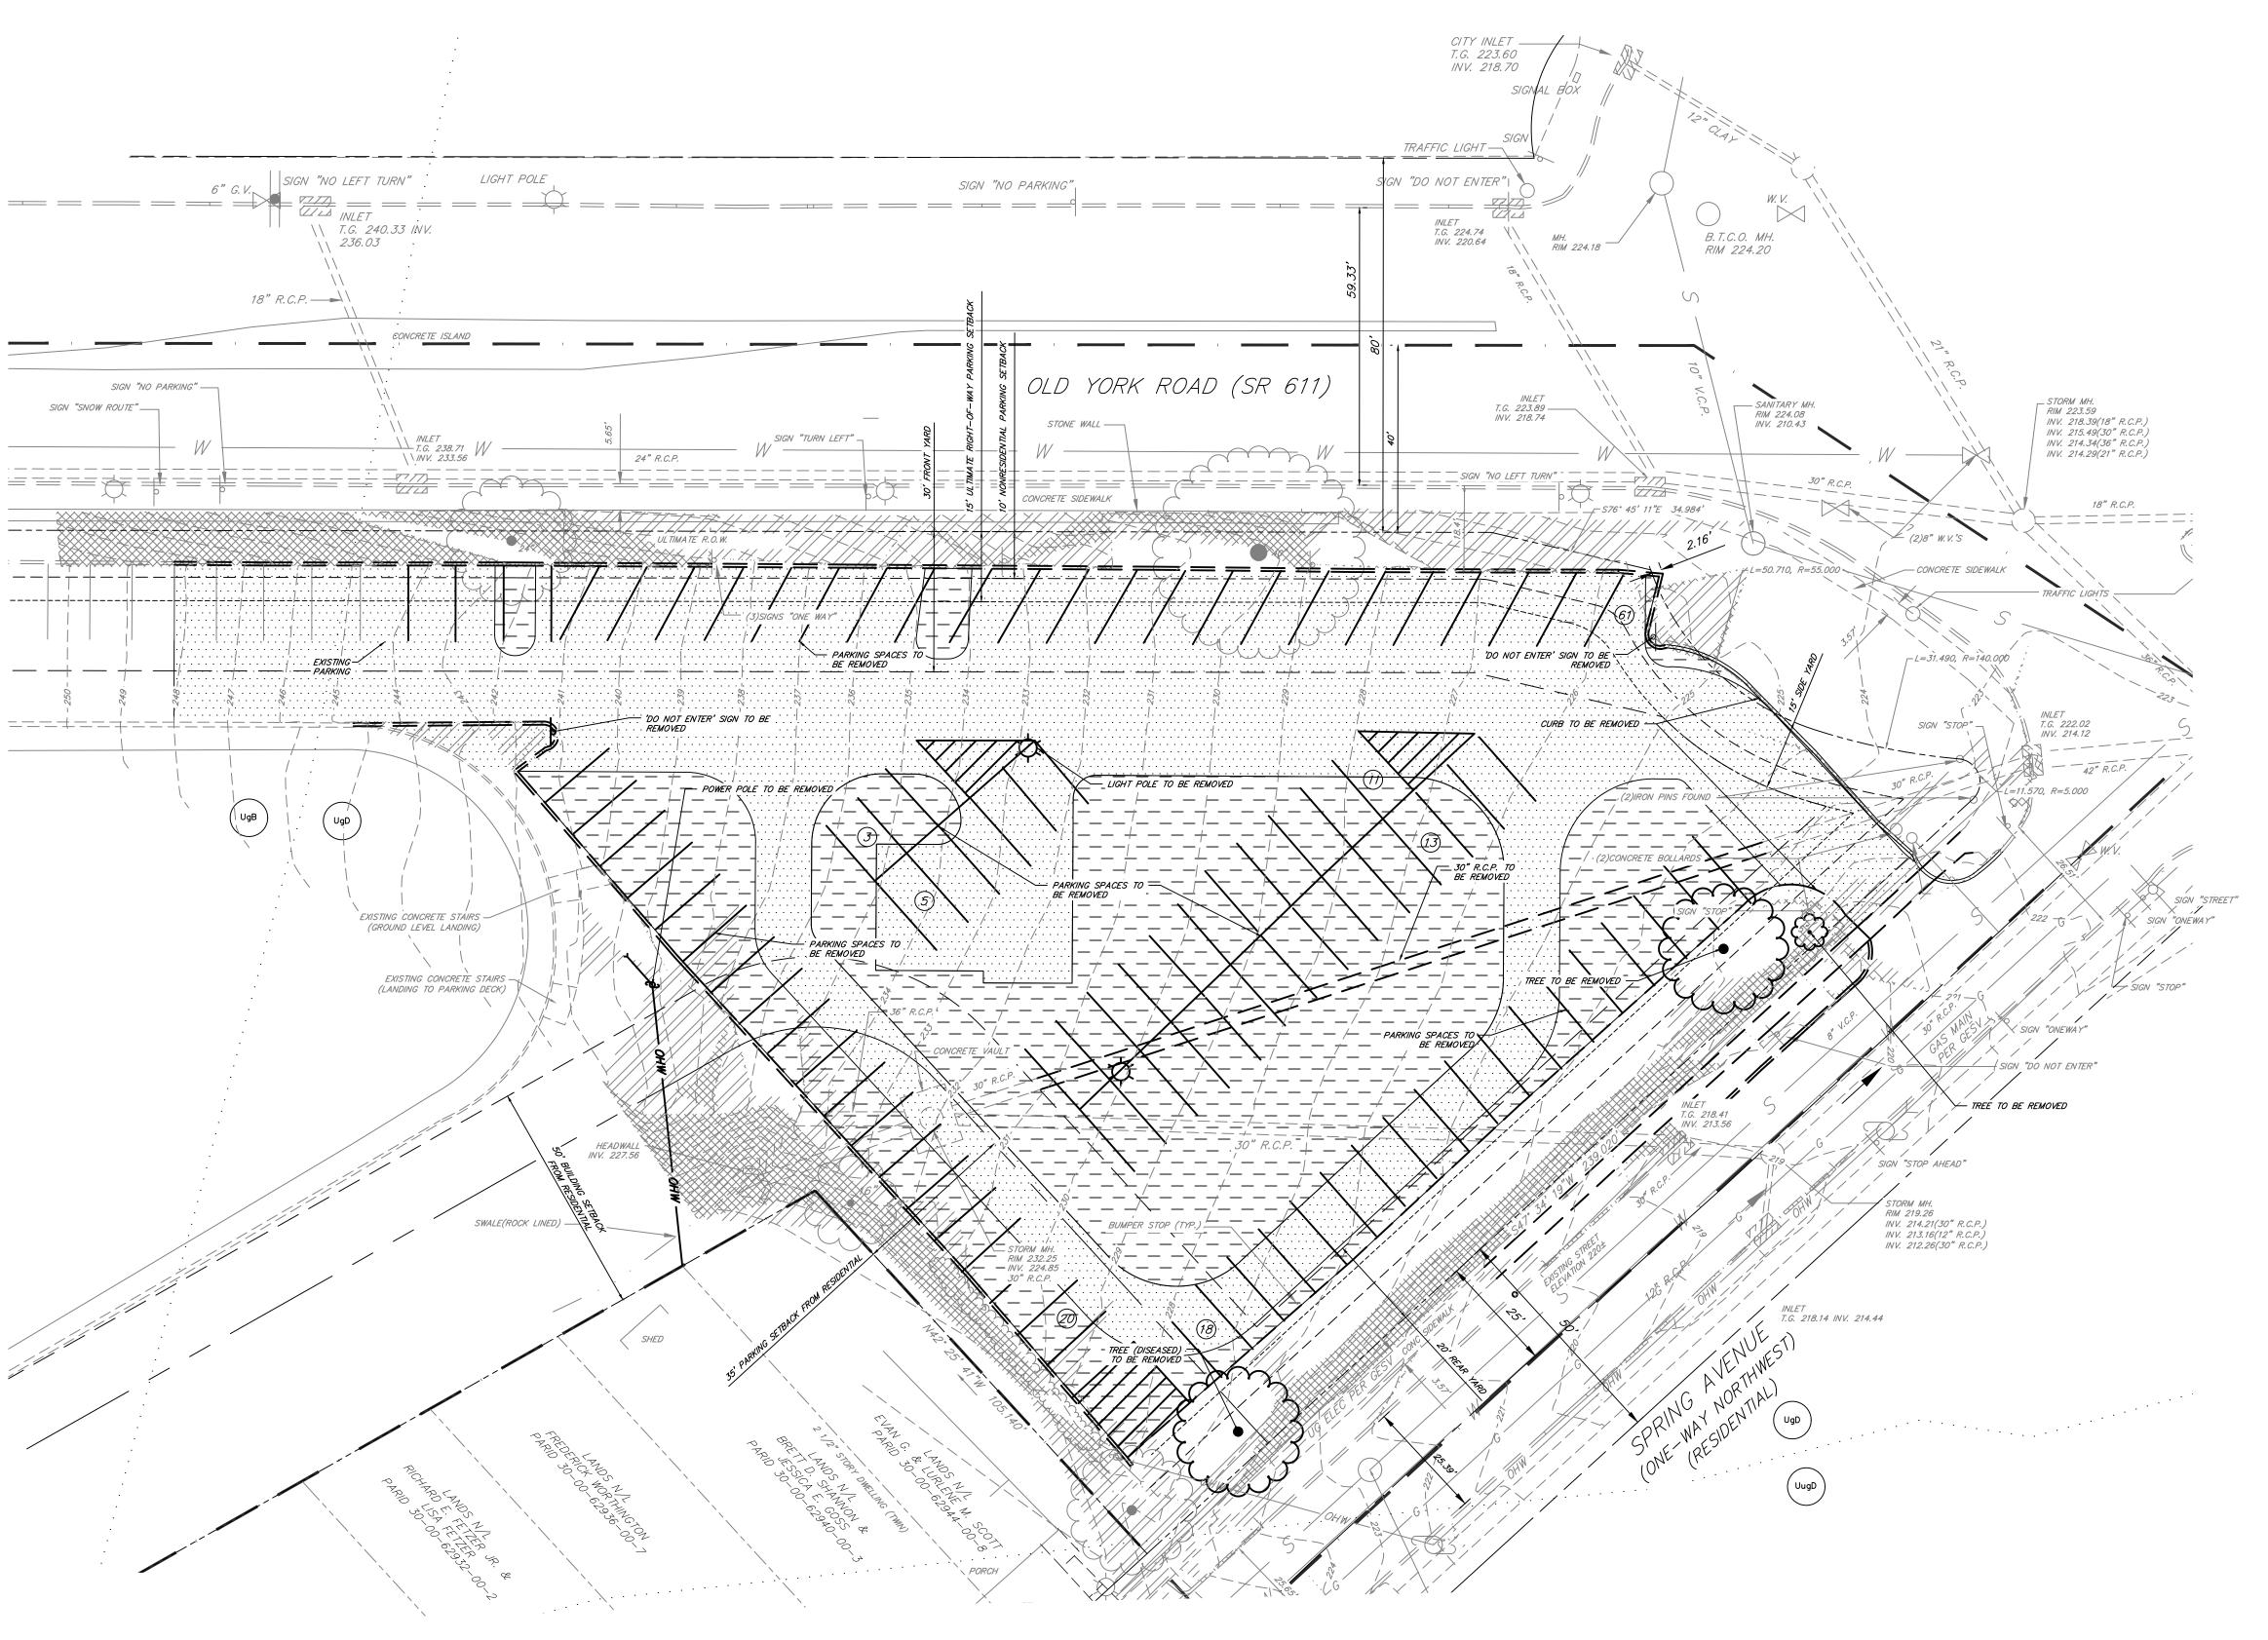


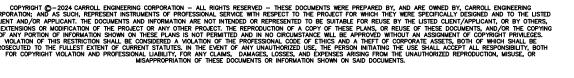

COVER SHEET DRAWING NUMBER-G-101 PLAN DATE: 03/29/2024



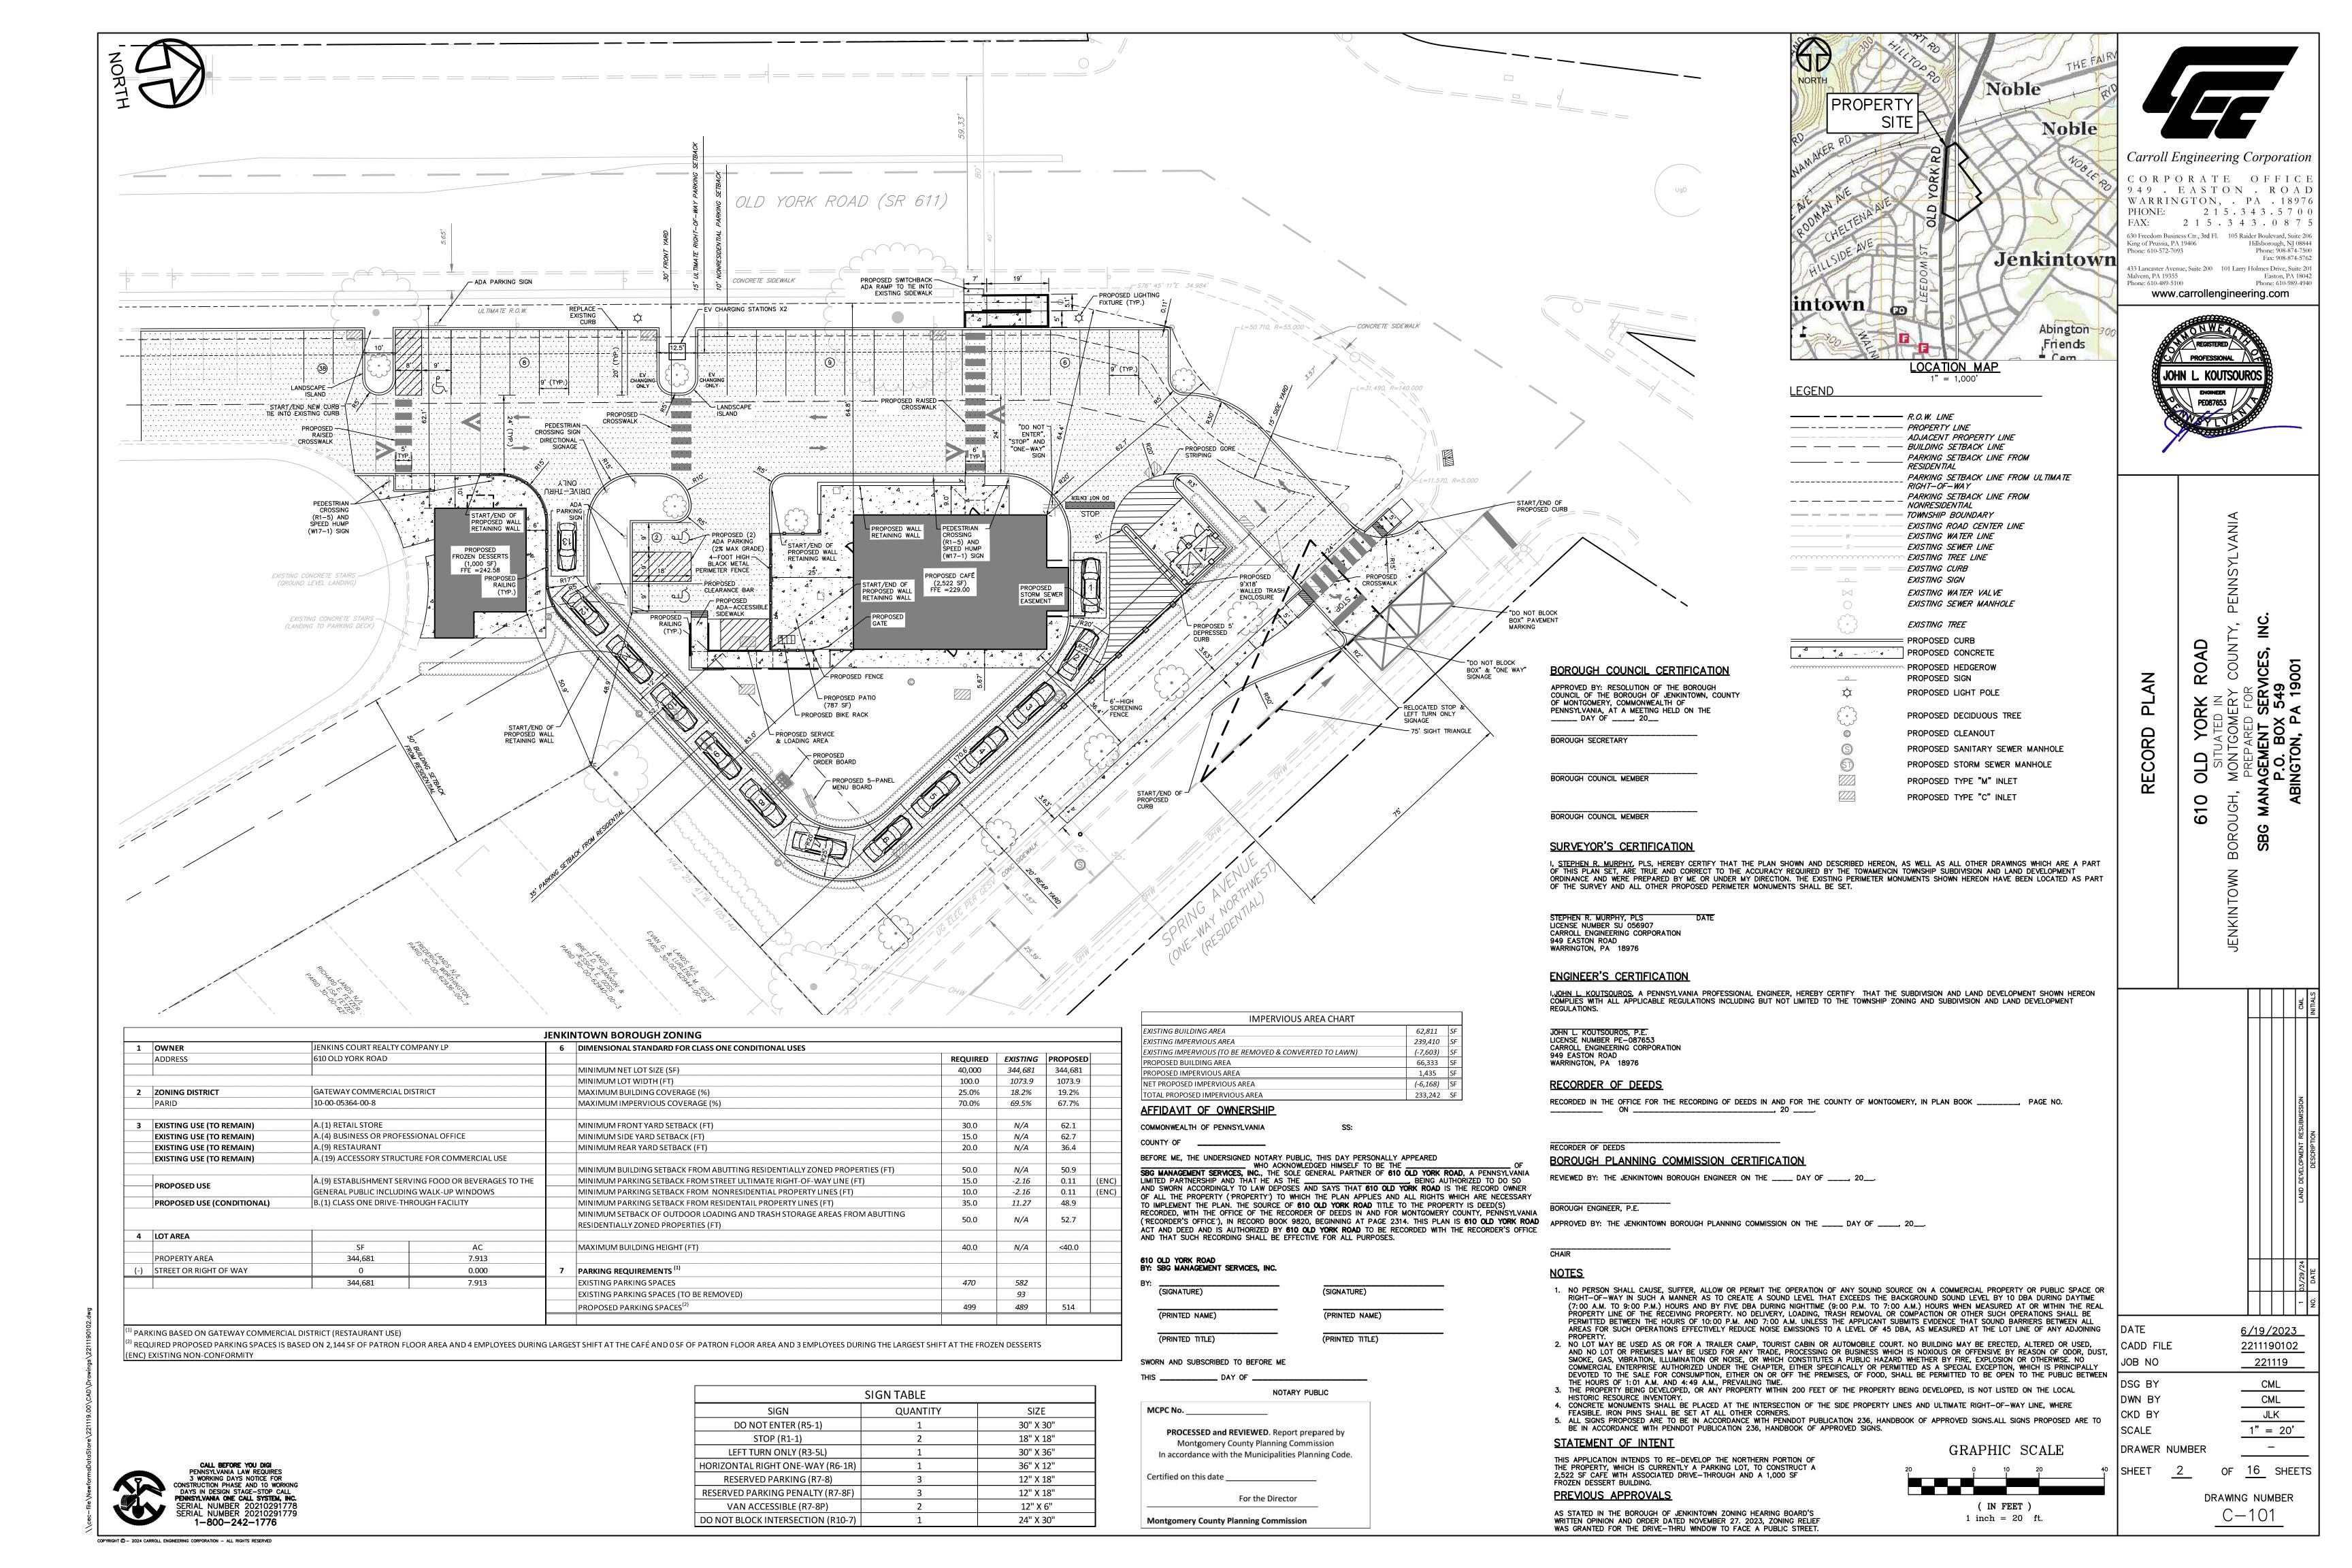


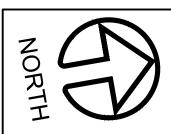

	NAT	URAL RESOUR	CE TABUL	ATION		
NATURAL FEATURE WITH ENVIRONMENTAL CONSTRAINT	MIN. PERCENTAGE OF FEATURE TO BE PRESERVED (%)	TOTAL AREA OF NATURAL FEATURE (AC)	NET AREA (ACRES)	RESOURCE PROTECTION LAND (ACRES X PROTECTION RATIO)	PROVIDED PROTECTION (ACRES)	NATURAL RESOURCE DISTURBANCE (ACRES)
FLOODPLAINS	100.0	0.000	0.000	0.00	0.00	0.00
WATERCOURSE	100.0	0.000	0.000	0.00	0.00	0.00
WETLANDS	100.0	0.000	0.000	0.00	0.00	0.00
PONDS	100.0	0.000	0.000	0.00	0.00	0.00
STREAM BUFFERS	100.0	0.000	0.000	0.00	0.00	0.00
VERY STEEP SLOPES (OVER 25%) (*)	100.0	0.000	0.000	0.00	0.00	0.00
STEEP SLOPES (15% - 25%) (*)	100.0	0.000	0.000	0.00	0.00	0.00
WOODLANDS	100.0	0.000	0.000	0.00	0.00	0.00
					0.00	
TOTAL LAND WITH RESOURCE RESTR	ICTIONS		0.000			
TOTAL LAND WITH 1.00 PROTECTION	RATIO RESOURCE REST	RICTIONS	0.000			
TOTAL RESOURCE PROTECTED LAND	REQUIRED			0.00		
TOTAL RESOURCE PROTECTED LAND	PROVIDED			0.00		
TOTAL DISTURBED RESOURCES						0.00

\* - All land disturbance within existing steep slopes shown are not naturally occurring due to past manmade activities.

	SOILS INFORMA	ATION TAB	LE		
MBOL	NAME	SLOPE (%)	HYDRIC SOIL	HYDROLIC SOIL GROUP	
UgB	URBAN LAND	0-8	NO	N/A	
UgD	URBAN LAND	8-25	NO	N/A	
UugD	URBAN LAND -UDORTHENTS, SCHIST AND GNEISS COMPLEX	8-25	NO	C	

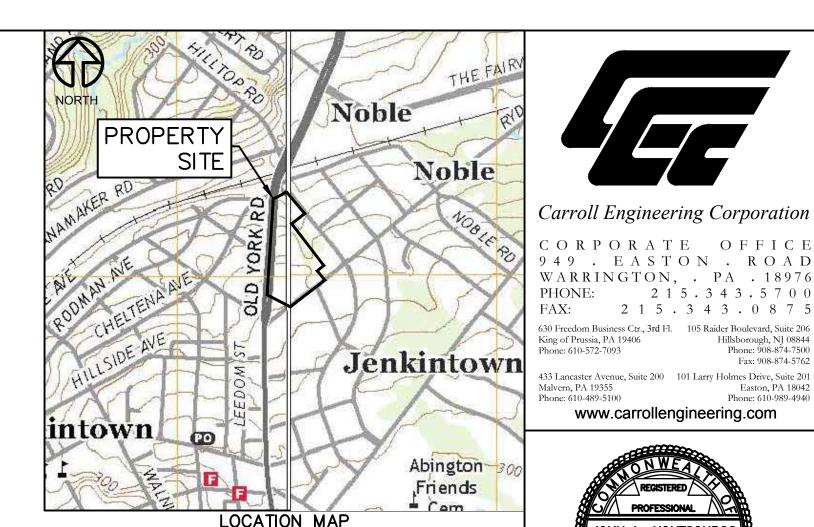

	- R.O.W. LINE
	- PROPERTY LINE
	ADJACENT PROPERTY LINE
	- EXISTING MAJOR CONTOUR I
	– EXISTING MINOR CONTOUR L
	- BUILDING SETBACK LINE
	_ PARKING SETBACK LINE FRO RESIDENTIAL
	PARKING SETBACK LINE FRO
	RIGHT-OF-WAY
	_ PARKING SETBACK LINE FRO NONRESIDENTIAL
	<i>TOWNSHIP BOUNDARY</i>
	– EXISTING ROAD CENTER LIN
	- EXISTING WATER LINE
	EXISTING SEWER LINE
========	
	EXISTING TREE LINE
	= EXISTING CURB
	EXISTING SIGN
<b>\$</b>	EXISTING LIGHT POLE
$\bowtie$	EXISTING WATER VALVE
	EXISTING INLET
	EXISTING UTILITY POLE
$\supset$	EXISTING STORM MANHOLE
$\bigcirc$	EXISTING SEWER MANHOLE
	EXISTING TREE
	EXISTING PARKING STALLS
	(TO BE REMOVED)
<b>Å</b>	EXISTING LIGHT POLE
~	(TO BE REMOVED)
	_EXISTING CURB
	(TO BE REMOVED)

EXISTING PAVEMENT MILLED/OVERLAID

EXISTING SOIL DESCRIPTION

1. LOCATIONS OF EXISTING UTILITIES SHOWN HEREON HAVE BEEN DEVELOPED FROM EXISTING RECORDS AND/OR ABOVE-GROUND OBSERVATIONS AT THE SITE. COMPLETENESS OR ACCURACY OF LOCATION AND DEPTH CANNOT BE GUARANTEED. ALL CONTRACTORS AND OTHER PERSONS UTILIZING THIS PLAN AND THE INFORMATION CONTAINED THEREON ARE CAUTIONED TO COMPLY WITH THE REQUIREMENTS OF PENNSYLVANIA ACT 38, ENTITLED "EXCAVATION AND DEMOLITION WORK PROTECTION OF UNDERGROUND UTILITIES." EACH INDIVIDUAL USING THIS PLAN MUST VERIFY LOCATION AND DEPTH OF ALL UNDERGROUND UTILITIES AND FACILITIES BEFORE STARTING WORK.

EXISTING STEEP SLOPE (10% TO 25%)

EXISTING STEEP SLOPE (> 25%)

\_\_\_\_\_ (TO BE REMOVED)

2.THE VERTICAL DATUM FOR THIS PROJECT IS BASED ON AN INLET GRATE LOCATED ON THE WESTERLY SIDE OF OLD YORK ROAD AT THE NORTHERLY CORNER OF MADEIRA AVENUE. SAID BENCHMARK WAS ESTABLISHED AS ELEVATION 260.57 AS SHOWN ON A PLAN PREPARED BY SHOEMAKER DATED 11-7-88 AND TITLED "TOPOGRAPHICAL PLAN OF PROPERTY MADE FOR M.S.K. ASSOCIATES, INC."

DATE
CADD FIL
JOB NO
200 214

DWN BY CKD BY SCALE

DRAWER NUMBER

OF 16 SHEETS SHEET

DRAWING NUMBER

6/19/2023 2211190103 221119


CML

JLK

1" = 20'


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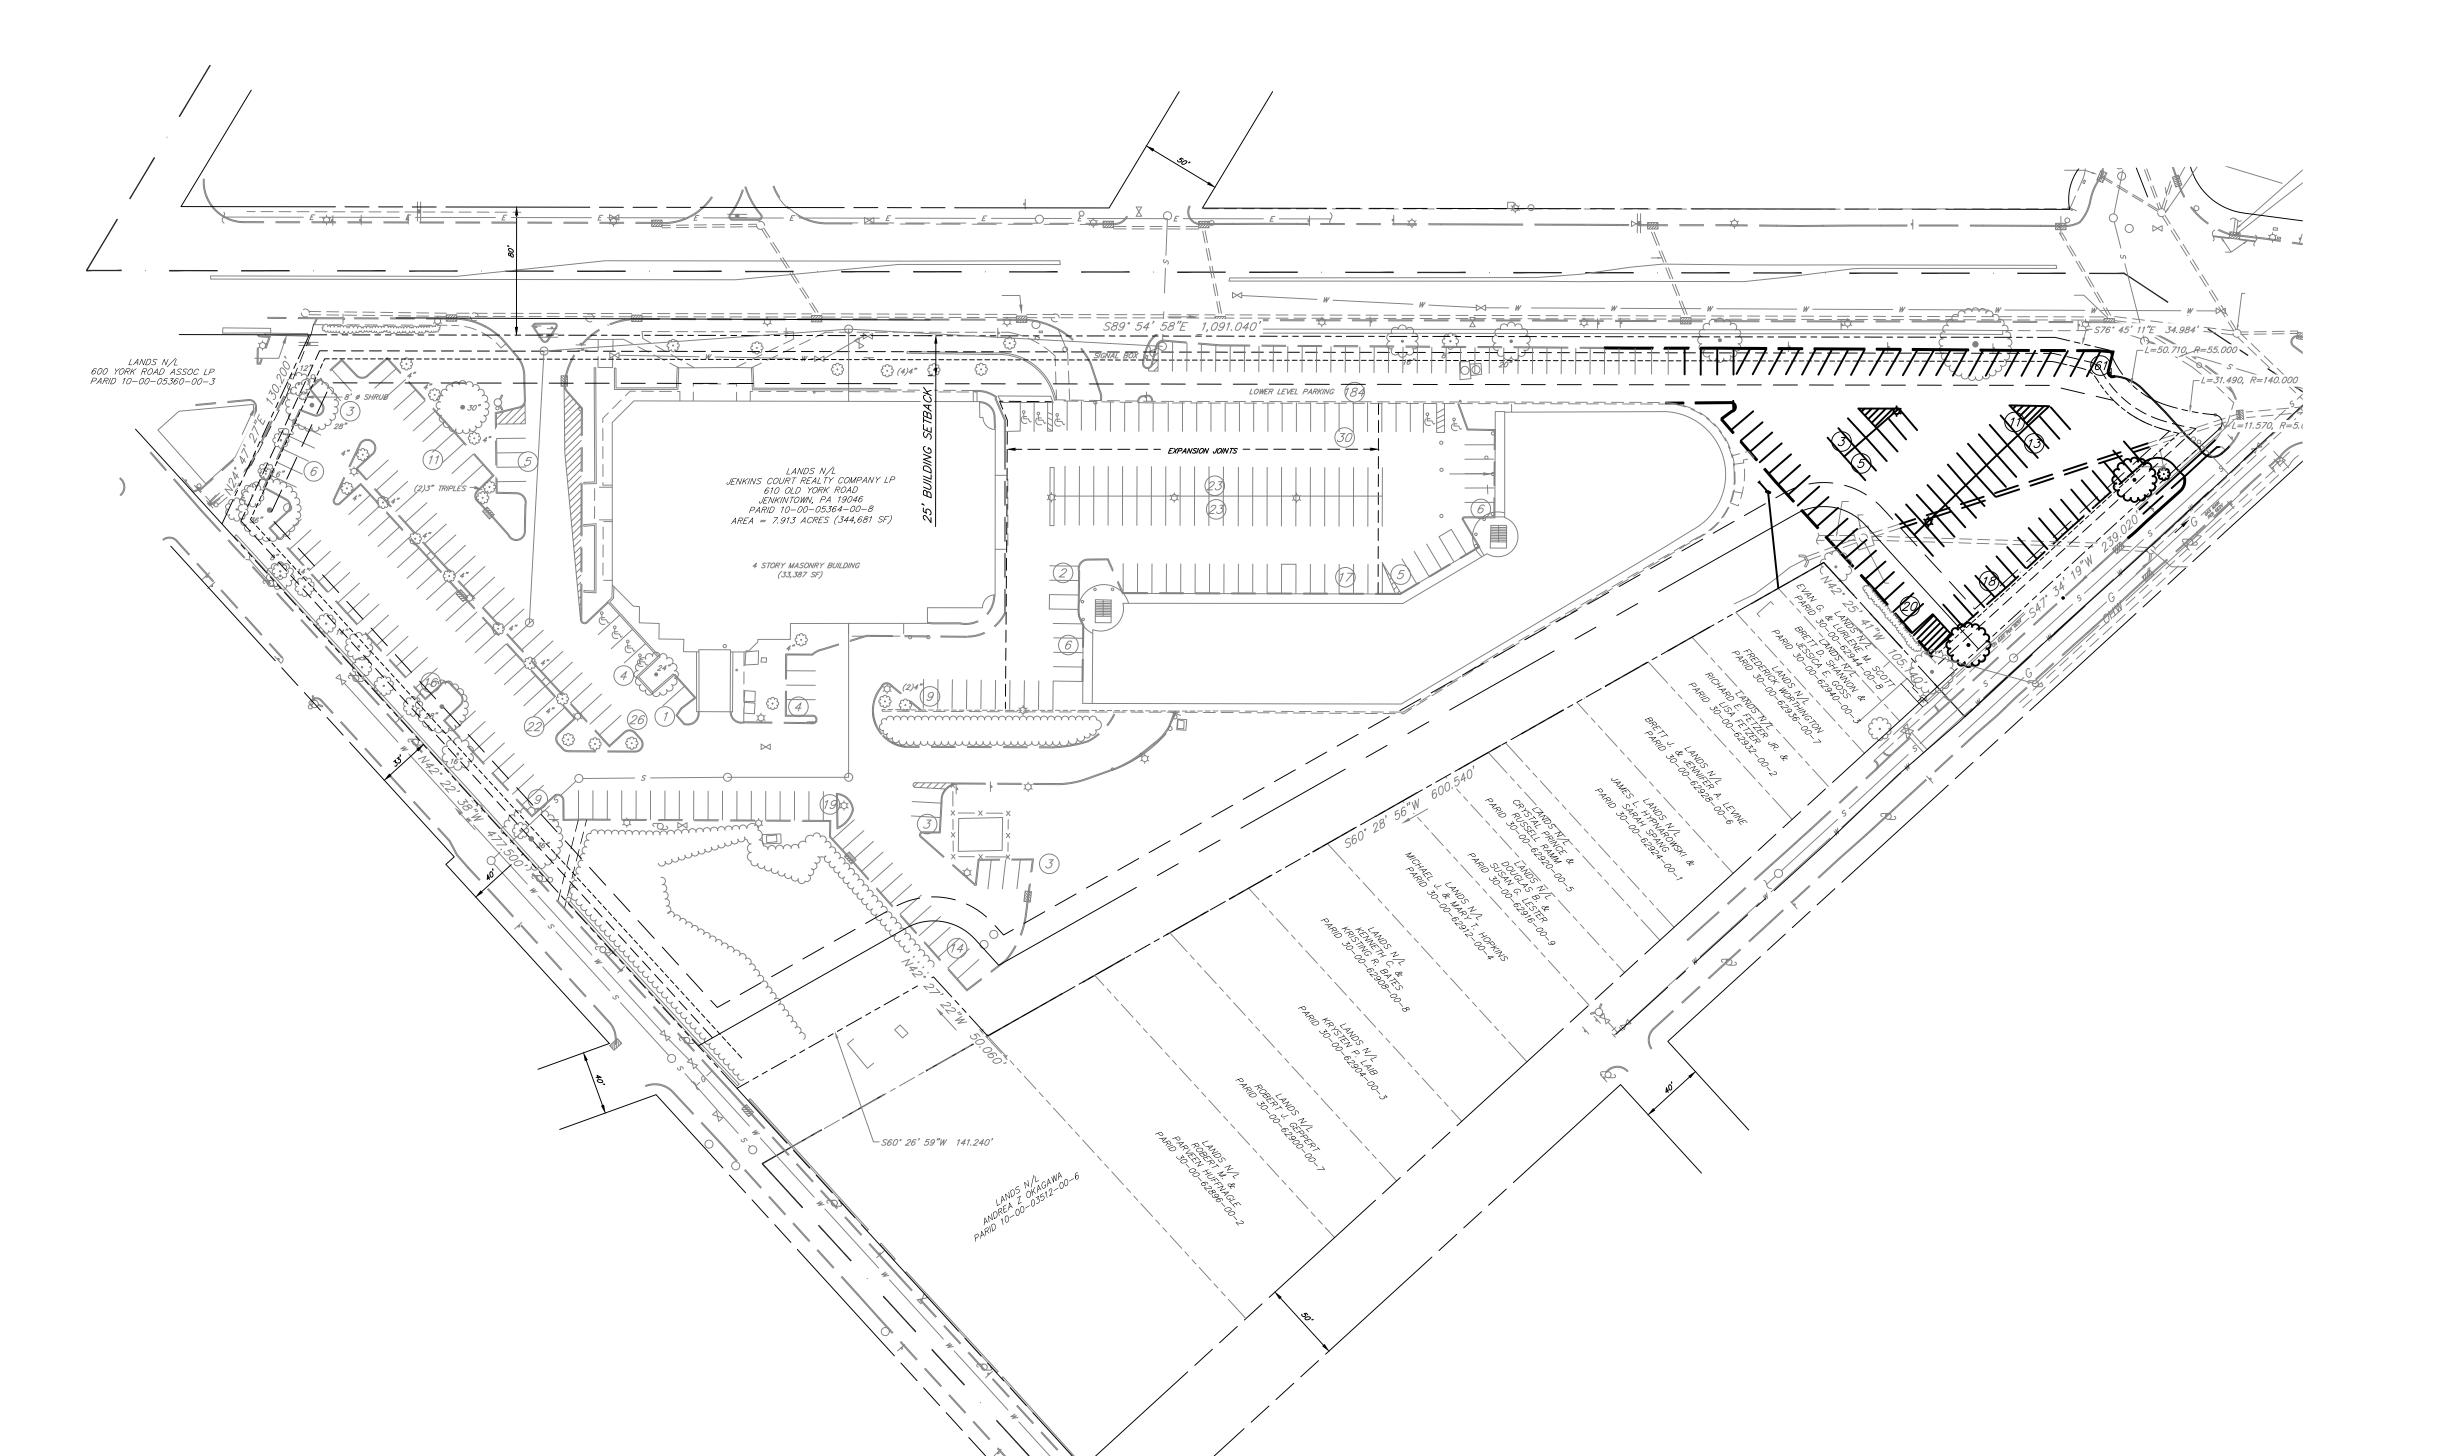
JOHN L. KOUTSOURO

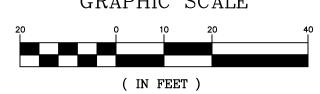


GRAPHIC SCALE 1 inch = 20 ft.

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## <u>LEGEND</u>

	R.O.W. LINE
	PROPERTY LINE
	ADJACENT PROPERTY LINE
	EXISTING MAJOR CONTOUR LINE
	EXISTING MINOR CONTOUR LINE
	BUILDING SETBACK LINE
	PARKING SETBACK LINE FROM RESIDENTIAL
	PARKING SETBACK LINE FROM ULTIMATE RIGHT-OF-WAY
	PARKING SETBACK LINE FROM NONRESIDENTIAL
	TOWNSHIP BOUNDARY
	EXISTING ROAD CENTER LINE
	EXISTING WATER LINE
	EXISTING SEWER LINE
=======	
	EXISTING CURB
	EXISTING SIGN
\$	EXISTING LIGHT POLE
$\bowtie$	EXISTING WATER VALVE
	EXISTING INLET
	EXISTING UTILITY POLE
$\supset$	EXISTING STORM MANHOLE
0	EXISTING SEWER MANHOLE
ۥ}	EXISTING TREE
	EXISTING PARKING STALLS (TO BE REMOVED)
ά	EXISTING LIGHT POLE
- <b></b>	(TO BE REMOVED)
	EXISTING CURB
	(TO BE REMOVED)

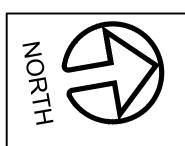


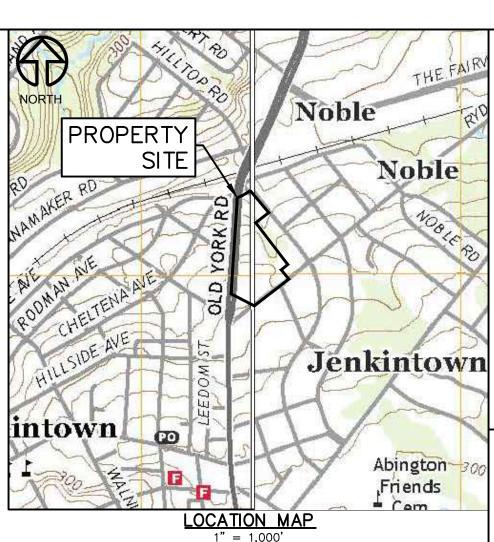Carroll Engineering Corporation

949 . EASTON . ROAD WARRINGTON, . PA . 18976 PHONE: 2 1 5 . 3 4 3 . 5 7 0 0 FAX: 2 1 5 . 3 4 3 . 0 8 7 630 Freedom Business Ctr., 3rd Fl.
King of Prussia, PA 19406
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SBG

6/19/2023 2211190104

CADD FILE 221119 JOB NO CML

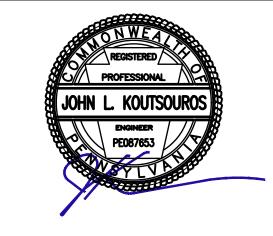CML

JLK

1" = 60' DWN BY

CKD BY SCALE


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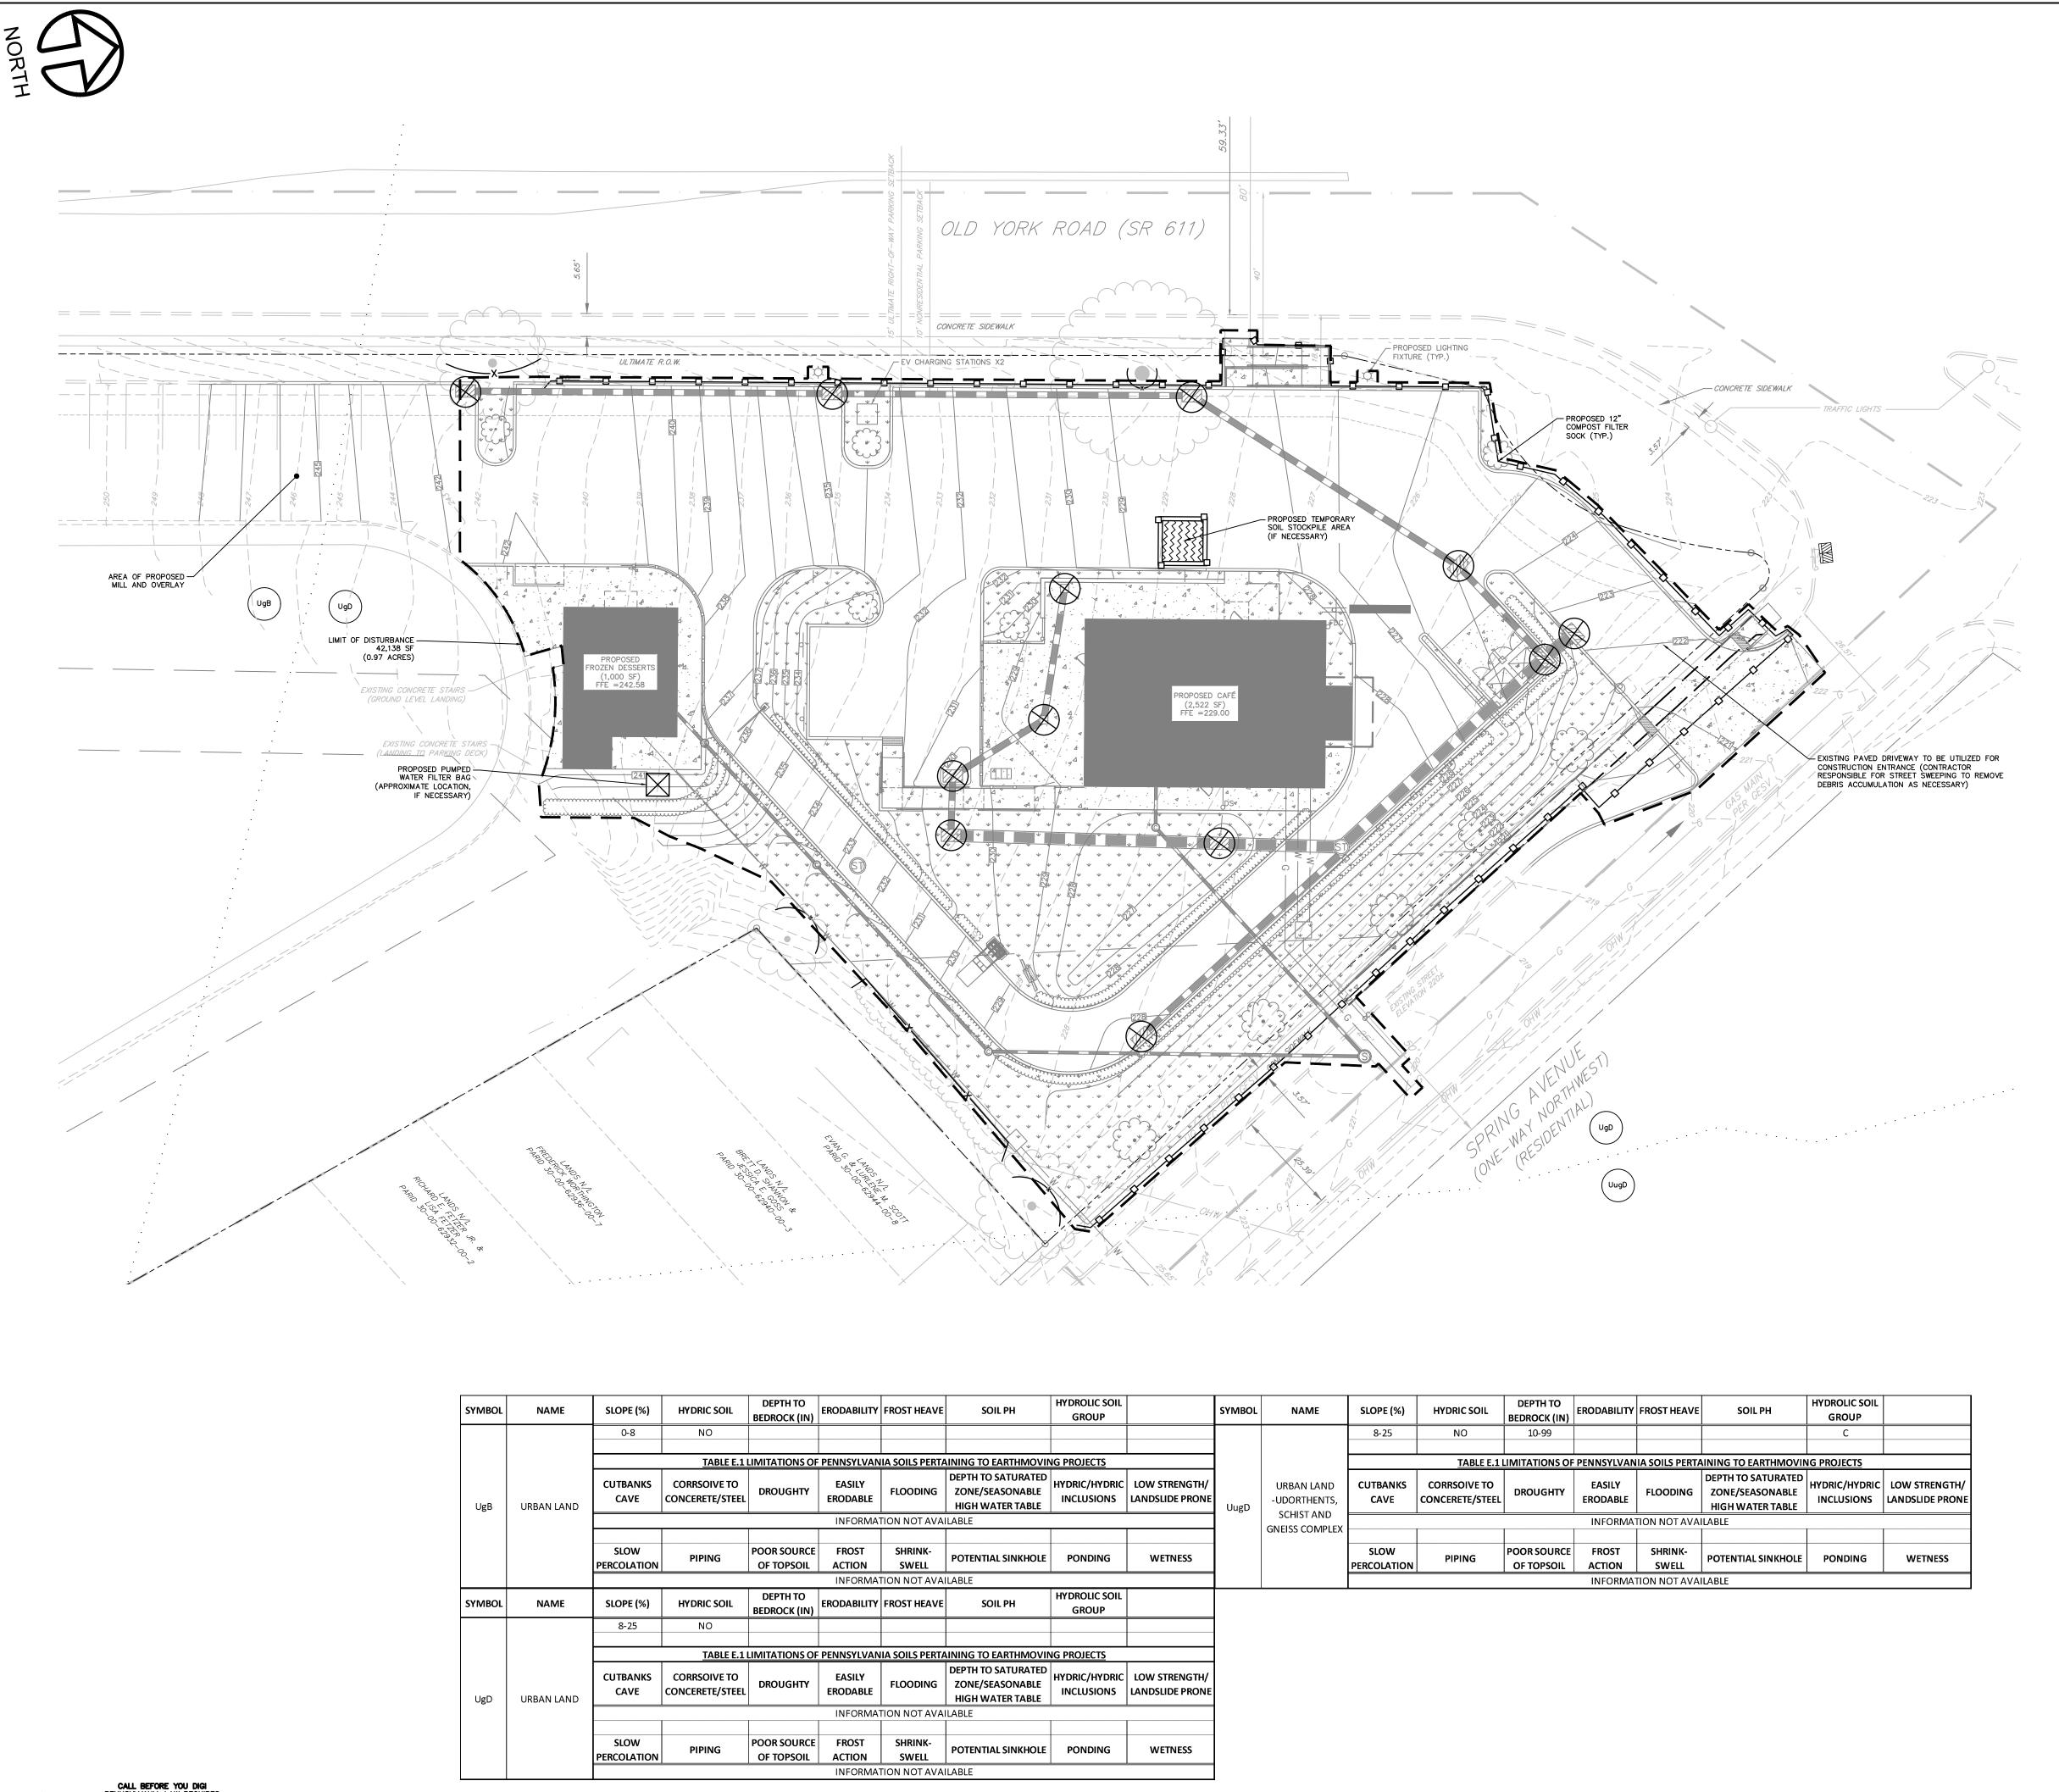
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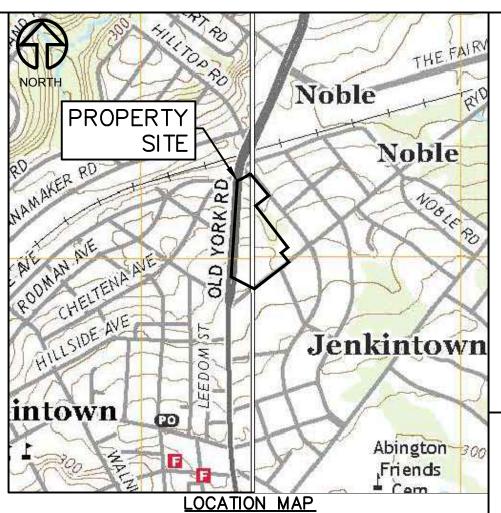
OF 16 SHEETS DRAWING NUMBER V-102



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	R.O.W. LINE
	PROPERTY LINE
	ADJACENT PROPERTY LINE
	EXISTING MAJOR CONTOUR LINE
<u> 239 </u>	EXISTING MINOR CONTOUR LINE
	BUILDING SETBACK LINE
	PARKING SETBACK LINE FROM RESIDENTIAL
	PARKING SETBACK LINE FROM ULTII RIGHT-OF-WAY
	PARKING SETBACK LINE FROM NONRESIDENTIAL
	TOWNSHIP BOUNDARY
	EXISTING ROAD CENTER LINE
	EXISTING TREE LINE
	FYISTING CURR

EXISTING SOIL DESCRIPTION

EXISTING TREE

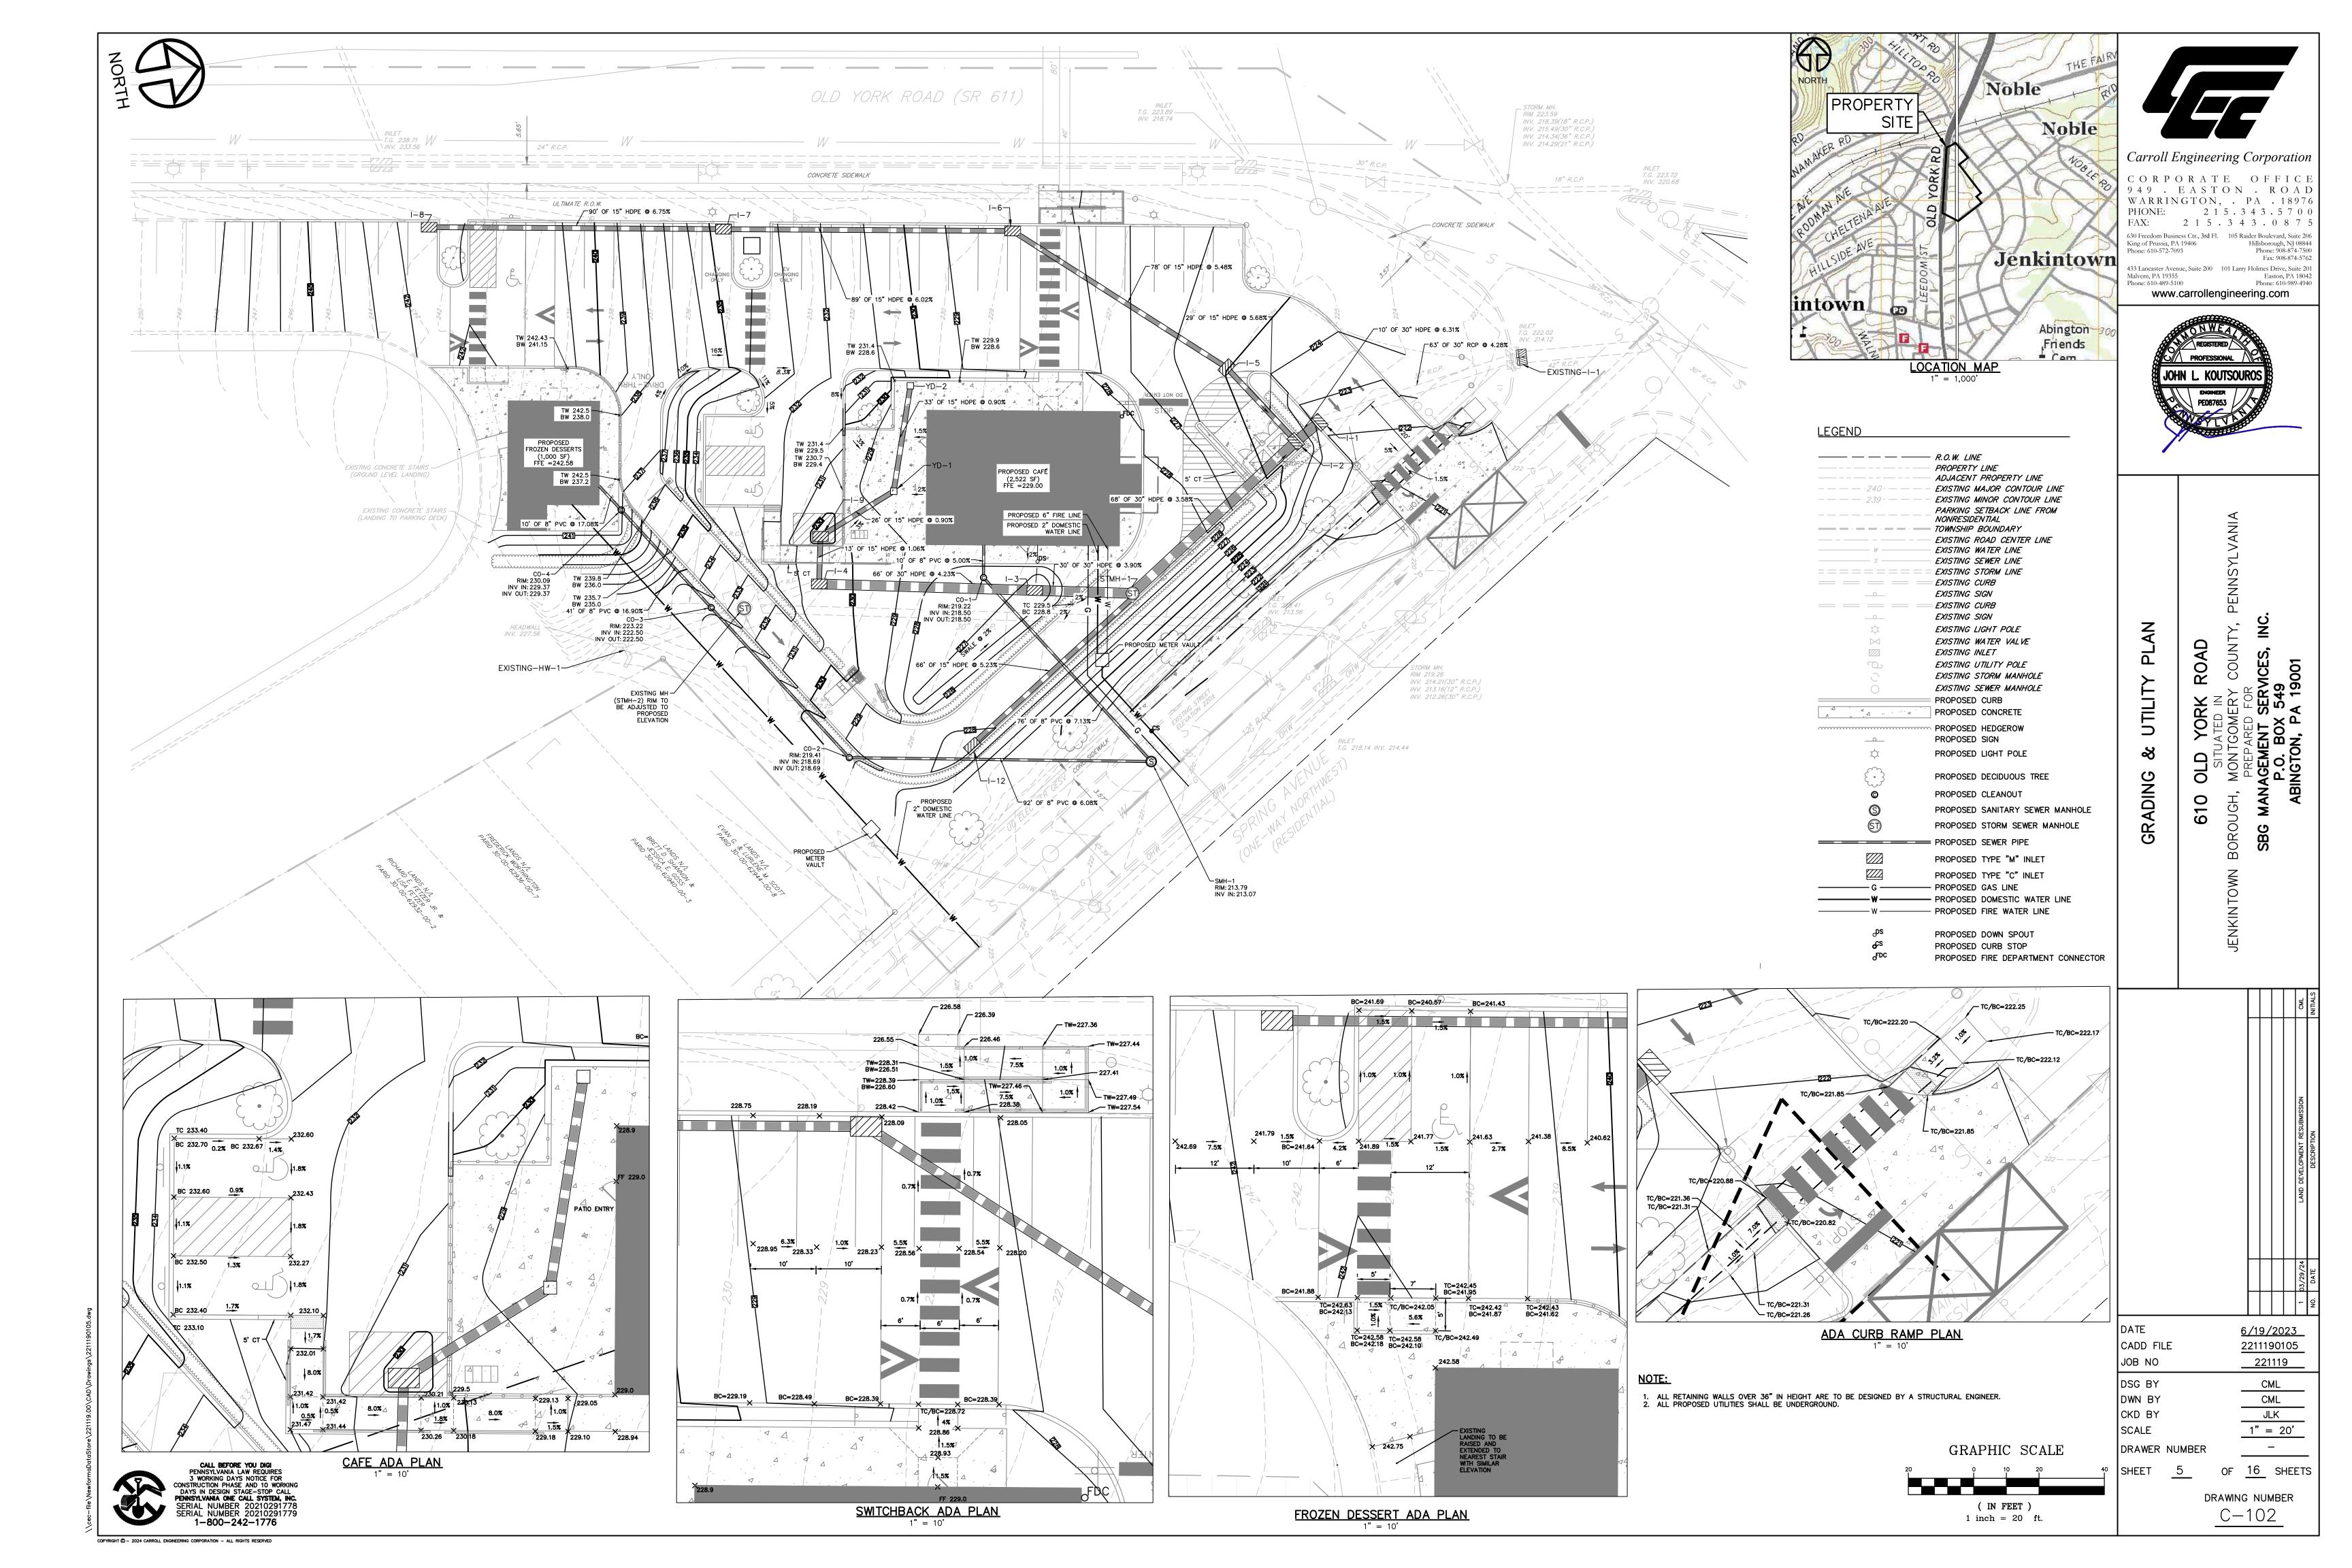EXISTING SOIL LINE SOIL STOCKPILE AREA


PROPOSED 12" COMPOST FILTER SOCK - PROPOSED TREE PROTECTION FENCING PROPOSED FILTER BAG INLET PROTECTION

	ROPOSED FILTER BAG INLET PROTECTION
	PROPOSED CURB PROPOSED CONCRETE
\(\psi\) \(\	PROPOSED LAWN CONVERSION
	PROPOSED HEDGEROW PROPOSED SIGN
\$	PROPOSED LIGHT POLE
	PROPOSED DECIDUOUS TREE
©	PROPOSED CLEANOUT
	PROPOSED SANITARY SEWER MANHOLE
	PROPOSED STORM SEWER MANHOLE

PROPOSED SEWER PIPE PROPOSED TYPE "M" INLET PROPOSED TYPE "C" INLET PROPOSED GAS LINE PROPOSED DOMESTIC WATER LINE PROPOSED FIRE WATER LINE

> PROPOSED DOWN SPOUT PROPOSED CURB STOP PROPOSED FIRE DEPARTMENT CONNECTOR

Carroll Engineering Corporation 949 . EASTON . ROAI WARRINGTON, . PA . 1897 PHONE: 2 1 5 . 3 4 3 . 5 7 0 0 FAX: 2 1 5 . 3 4 3 . 0 8 7 630 Freedom Business Ctr., 3rd Fl. 105 Raider Boulevard, Suite 200 King of Prussia, PA 19406 105 Raider Boulevard, Suite 200 Hillsborough, NJ 08844 433 Lancaster Avenue, Suite 200 101 Larry Holmes Drive, Suite 20 Malvern, PA 19355

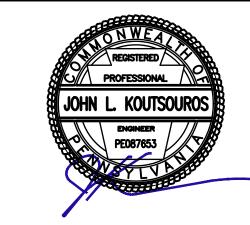

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CONTROL

ROAD

6/19/2023

DATE CADD FILE 2211190107 221119 JOB NO CML CML DWN BY JLK 1" = 20' CKD BY

SCALE DRAWER NUMBER


SHEET 6

OF 16 SHEETS DRAWING NUMBER CJ-101

GRAPHIC SCALE ( IN FEET )

1 inch = 20 ft.

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USGS LOCATION MAP

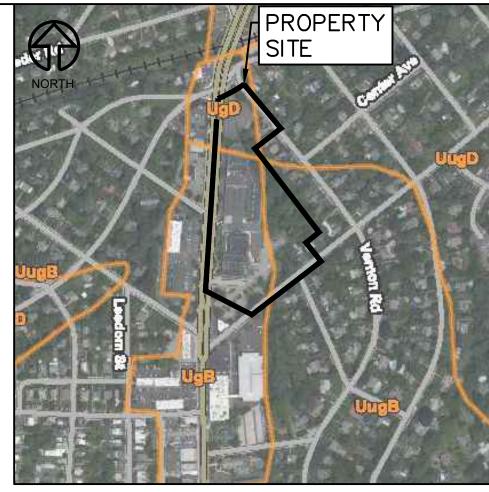SCALE: 1" = 1,000'

SOILS MAF

## MCCD STANDARD E&S PLAN NOTES:


- 1. ALL EARTH DISTURBANCES, INCLUDING CLEARING AND GRUBBING AS WELL AS CUTS AND FILLS SHALL BE DONE IN ACCORDANCE WITH THE APPROVED E&S PLAN. A COPY OF THE APPROVED DRAWINGS (STAMPED, SIGNED AND DATED BY THE REVIEWING AGENCY) MUST BE AVAILABLE AT THE PROJECT SITE AT ALL TIMES. THE REVIEWING AGENCY SHALL BE NOTIFIED OF ANY CHANGES TO THE APPROVED PLAN PRIOR TO IMPLEMENTATION OF THOSE CHANGES. THE REVIEWING AGENCY MAY REQUIRE A WRITTEN SUBMITTAL OF THOSE CHANGES FOR REVIEW AND APPROVAL AT ITS DISCRETION.
- 2. AT LEAST 7 DAYS PRIOR TO STARTING ANY EARTH DISTURBANCE ACTIVITIES, INCLUDING CLEARING AND GRUBBING, THE OWNER AND/OR OPERATOR SHALL INVITE ALL CONTRACTORS, THE LANDOWNER, APPROPRIATE MUNICIPAL OFFICIALS, THE E&S PLAN PREPARER, THE PCSM PLAN PREPARER, THE LICENSED PROFESSIONAL RESPONSIBLE FOR OVERSIGHT OF CRITICAL STAGES OF IMPLEMENTATION OF THE PCSM PLAN, AND A REPRESENTATIVE FROM THE LOCAL CONSERVATION DISTRICT TO AN ON-SITE PRECONSTRUCTION MEETING.
- 3. AT LEAST 3 DAYS PRIOR TO STARTING ANY EARTH DISTURBANCE ACTIVITIES, OR EXPANDING INTO AN AREA PREVIOUSLY UNMARKED, THE PENNSYLVANIA ONE CALL SYSTEM INC. SHALL BE NOTIFIED AT 1-800-242-1776 FOR THE LOCATION OF EXISTING UNDERGROUND UTILITIES.
- 4. ALL EARTH DISTURBANCE ACTIVITIES SHALL PROCEED IN ACCORDANCE WITH THE SEQUENCE PROVIDED ON THE PLAN DRAWINGS. DEVIATION FROM THAT SEQUENCE MUST BE APPROVED IN WRITING FROM THE LOCAL CONSERVATION DISTRICT OR BY THE DEPARTMENT PRIOR TO IMPLEMENTATION.
- 5. AREAS TO BE FILLED ARE TO BE CLEARED, GRUBBED, AND STRIPPED OF TOPSOIL TO REMOVE TREES, VEGETATION, ROOTS AND OTHER OBJECTIONABLE MATERIAL.

  6. CLEARING, GRUBBING, AND TOPSOIL STRIPPING SHALL BE LIMITED TO THOSE AREAS DESCRIBED IN EACH STAGE OF THE CONSTRUCTION SEQUENCE. GENERAL SITE CLEARING, GRUBBING AND TOPSOIL STRIPPING MAY NOT COMMENCE IN ANY STAGE OR PHASE OF THE PROJECT UNTIL THE E&S BMPS SPECIFIED BY THE BMP SEQUENCE FOR THAT STAGE OR PHASE HAVE BEEN INSTALLED AND ARE FUNCTIONING AS DESCRIBED IN THIS E&S PLAN.
- 7. AT NO TIME SHALL CONSTRUCTION VEHICLES BE ALLOWED TO ENTER AREAS OUTSIDE THE LIMIT OF DISTURBANCE BOUNDARIES SHOWN ON THE PLAN MAPS. THESE AREAS MUST BE CLEARLY MARKED AND FENCED OFF BEFORE CLEARING AND GRUBBING OPERATIONS BEGIN.
- 8. TOPSOIL REQUIRED FOR THE ESTABLISHMENT OF VEGETATION SHALL BE STOCKPILED AT THE LOCATION(S) SHOWN ON THE PLAN MAPS(S) IN THE AMOUNT NECESSARY TO COMPLETE THE FINISH GRADING OF ALL EXPOSED AREAS THAT ARE TO BE STABILIZED BY VEGETATION. EACH STOCKPILE SHALL BE PROTECTED IN THE MANNER SHOWN ON THE PLAN DRAWINGS. STOCKPILE HEIGHTS SHALL NOT EXCEED 35 FEET. STOCKPILE SLOPES SHALL BE 2H:1V OR FLATTER.
- 9. IMMEDIATELY UPON DISCOVERING UNFORESEEN CIRCUMSTANCES POSING THE POTENTIAL FOR ACCELERATED EROSION AND/OR SEDIMENT POLLUTION, THE OPERATOR SHALL IMPLEMENT APPROPRIATE BEST MANAGEMENT PRACTICES TO MINIMIZE THE POTENTIAL FOR EROSION AND SEDIMENT POLLUTION AND NOTIFY THE LOCAL CONSERVATION DISTRICT AND/OR THE REGIONAL OFFICE OF THE DEPARTMENT.
- 10. ALL BUILDING MATERIALS AND WASTES SHALL BE REMOVED FROM THE SITE AND RECYCLED OR DISPOSED OF IN ACCORDANCE WITH THE DEPARTMENT'S SOLID WASTE MANAGEMENT REGULATIONS AT 25 PA. CODE 260.1 ET SEQ., 271.1, AND 287.1 ET. SEQ. NO BUILDING MATERIALS OR WASTES OR UNUSED BUILDING MATERIALS SHALL BE BURNED, BURIED, DUMPED, OR DISCHARGED AT THE SITE.
- 11. ALL OFF—SITE WASTE AND BORROW AREAS MUST HAVE AN E&S PLAN APPROVED BY THE LOCAL CONSERVATION DISTRICT OR THE DEPARTMENT FULLY IMPLEMENTED PRIOR TO BEING ACTIVATED.
- 12. THE CONTRACTOR IS RESPONSIBLE FOR ENSURING THAT ANY MATERIAL BROUGHT ON SITE IS CLEAN FILL. FORM FP-001 MUST BE RETAINED BY THE PROPERTY OWNER FOR ANY FILL MATERIAL AFFECTED BY A SPILL OR RELEASE OF A REGULATED SUBSTANCE BUT QUALIFYING AS CLEAN FILL DUE TO ANALYTICAL TESTING.


  13. ALL PUMPING OF WATER FROM ANY WORK AREA SHALL BE DONE ACCORDING TO THE PROCEDURE DESCRIBED IN THIS PLAN, OVER UNDISTURBED VEGETATED
- 14. VEHICLES AND EQUIPMENT MAY NEITHER ENTER DIRECTLY NOR EXIT DIRECTLY FROM LOT (10-00-05364-00-8) ONTO OLD YORK ROAD (SR 611).
- 15. UNTIL THE SITE IS STABILIZED, ALL EROSION AND SEDIMENT BMPS SHALL BE MAINTAINED PROPERLY. MAINTENANCE SHALL INCLUDE INSPECTIONS OF ALL EROSION AND SEDIMENT BMPS AFTER EACH RUNOFF EVENT AND ON A WEEKLY BASIS. ALL PREVENTATIVE AND REMEDIAL MAINTENANCE WORK, INCLUDING CLEAN OUT, REPAIR, REPLACEMENT, REGRADING, RESEEDING, REMULCHING AND RENETTING MUST BE PERFORMED IMMEDIATELY. IF THE E&S BMPS FAIL TO PERFORM AS EXPECTED, REPLACEMENT BMPS, OR MODIFICATIONS OF THOSE INSTALLED WILL BE REQUIRED.
- 16. A LOG SHOWING DATES THAT E&S BMPS WERE INSPECTED AS WELL AS ANY DEFICIENCIES FOUND AND THE DATE THEY WERE CORRECTED SHALL BE MAINTAINED ON THE SITE AND BE MADE AVAILABLE TO REGULATORY AGENCY OFFICIALS AT THE TIME OF INSPECTION.
- 17. SEDIMENT TRACKED ONTO ANY PUBLIC ROADWAY OR SIDEWALK SHALL BE RETURNED TO THE CONSTRUCTION SITE BY THE END OF EACH WORK DAY AND DISPOSED IN THE MANNER DESCRIBED IN THIS PLAN. IN NO CASE SHALL THE SEDIMENT BE WASHED, SHOVELED, OR SWEPT INTO ANY ROADSIDE DITCH, STORM SEWER, OR SURFACE WATER.
- 18. ALL SEDIMENT REMOVED FROM BMPS SHALL BE DISPOSED OF IN THE MANNER DESCRIBED ON THE PLAN DRAWINGS.
- 19. AREAS WHICH ARE TO BE TOPSOILED SHALL BE SCARIFIED TO A MINIMUM DEPTH OF 3 TO 5 INCHES -- 6 TO 12 INCHES ON COMPACTED SOILS -- PRIOR TO PLACEMENT OF TOPSOIL. AREAS TO BE VEGETATED SHALL HAVE A MINIMUM 4 INCHES OF TOPSOIL IN PLACE PRIOR TO SEEDING AND MULCHING. FILL OUTSLOPES SHALL HAVE A MINIMUM OF 2 INCHES OF TOPSOIL.
- 20. ALL FILLS SHALL BE COMPACTED AS REQUIRED TO REDUCE EROSION, SLIPPAGE, SETTLEMENT, SUBSIDENCE OR OTHER RELATED PROBLEMS. FILL INTENDED TO SUPPORT BUILDINGS, STRUCTURES AND CONDUITS, ETC. SHALL BE COMPACTED IN ACCORDANCE WITH LOCAL REQUIREMENTS OR CODES.
- 21. ALL EARTHEN FILLS SHALL BE PLACED IN COMPACTED LAYERS NOT TO EXCEED 9 INCHES IN THICKNESS.
- 22. FILL MATERIALS SHALL BE FREE OF FROZEN PARTICLES, BRUSH, ROOTS, SOD, OR OTHER FOREIGN OR OBJECTIONABLE MATERIALS THAT WOULD INTERFERE WITH OR PREVENT CONSTRUCTION OF SATISFACTORY FILLS.
- 23. FROZEN MATERIALS OR SOFT, MUCKY, OR HIGHLY COMPRESSIBLE MATERIALS SHALL NOT BE INCORPORATED INTO FILLS.
- 24. FILL SHALL NOT BE PLACED ON SATURATED OR FROZEN SURFACES.

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- 25. SEEPS OR SPRINGS ENCOUNTERED DURING CONSTRUCTION SHALL BE HANDLED IN ACCORDANCE WITH THE STANDARD AND SPECIFICATION FOR SUBSURFACE DRAIN OR OTHER APPROVED METHOD.
- 26. ALL GRADED AREAS SHALL BE PERMANENTLY STABILIZED IMMEDIATELY UPON REACHING FINISHED GRADE. CUT SLOPES IN COMPETENT BEDROCK AND ROCK FILLS NEED NOT BE VEGETATED. SEEDED AREAS WITHIN 50 FEET OF A SURFACE WATER, OR AS OTHERWISE SHOWN ON THE PLAN DRAWINGS, SHALL BE BLANKETED ACCORDING TO THE STANDARDS OF THIS PLAN.
- 27. IMMEDIATELY AFTER EARTH DISTURBANCE ACTIVITIES CEASE IN ANY AREA OR SUBAREA OF THE PROJECT, THE OPERATOR SHALL STABILIZE ALL DISTURBED AREAS. DURING NON-GERMINATING MONTHS, MULCH OR PROTECTIVE BLANKETING SHALL BE APPLIED AS DESCRIBED IN THE PLAN. AREAS NOT AT FINISHED GRADE, WHICH WILL BE REACTIVATED WITHIN 1 YEAR, MAY BE STABILIZED IN ACCORDANCE WITH THE TEMPORARY STABILIZATION SPECIFICATIONS. THOSE AREAS WHICH WILL NOT BE REACTIVATED WITHIN 1 YEAR SHALL BE STABILIZED IN ACCORDANCE WITH THE PERMANENT STABILIZATION SPECIFICATIONS.
- 28. PERMANENT STABILIZATION IS DEFINED AS A MINIMUM UNIFORM, PERENNIAL 70% VEGETATIVE COVER OR OTHER PERMANENT NON—VEGETATIVE COVER WITH A DENSITY SUFFICIENT TO RESIST ACCELERATED EROSION. CUT AND FILL SLOPES SHALL BE CAPABLE OF RESISTING FAILURE DUE TO SLUMPING, SLIDING, OR OTHER MOVEMENTS.
- 29. E&S BMPS SHALL REMAIN FUNCTIONAL AS SUCH UNTIL ALL AREAS TRIBUTARY TO THEM ARE PERMANENTLY STABILIZED OR UNTIL THEY ARE REPLACED BY ANOTHER BMP APPROVED BY THE LOCAL CONSERVATION DISTRICT OR THE DEPARTMENT.
- 30. UPON COMPLETION OF ALL EARTH DISTURBANCE ACTIVITIES AND PERMANENT STABILIZATION OF ALL DISTURBED AREAS, THE OWNER AND/OR OPERATOR SHALL CONTACT THE LOCAL CONSERVATION DISTRICT FOR AN INSPECTION PRIOR TO REMOVAL/CONVERSION OF THE E&S BMPS.
- 31. AFTER FINAL SITE STABILIZATION HAS BEEN ACHIEVED, TEMPORARY EROSION AND SEDIMENT BMPS MUST BE REMOVED OR CONVERTED TO PERMANENT POST CONSTRUCTION STORMWATER MANAGEMENT BMPS. AREAS DISTURBED DURING REMOVAL OR CONVERSION OF THE BMPS SHALL BE STABILIZED IMMEDIATELY. IN ORDER TO ENSURE RAPID REVEGETATION OF DISTURBED AREAS, SUCH REMOVAL/CONVERSIONS ARE TO BE DONE ONLY DURING THE GERMINATING SEASON.
- 32. UPON COMPLETION OF ALL EARTH DISTURBANCE ACTIVITIES AND PERMANENT STABILIZATION OF ALL DISTURBED AREAS, THE OWNER AND/OR OPERATOR SHALL
- CONTACT THE LOCAL CONSERVATION DISTRICT TO SCHEDULE A FINAL INSPECTION.
- 33. FAILURE TO CORRECTLY INSTALL E&S BMPS, FAILURE TO PREVENT SEDIMENT-LADEN RUNOFF FROM LEAVING THE CONSTRUCTION SITE, OR FAILURE TO TAKE IMMEDIATE CORRECTIVE ACTION TO RESOLVE FAILURE OF E&S BMPS MAY RESULT IN ADMINISTRATIVE, CIVIL, AND/OR CRIMINAL PENALTIES BEING INSTITUTED BY THE DEPARTMENT AS DEFINED IN SECTION 602 OF THE PENNSYLVANIA CLEAN STREAMS LAW. THE CLEAN STREAMS LAW PROVIDES FOR UP TO \$10,000 PER DAY IN CIVIL PENALTIES, UP TO \$10,000 IN SUMMARY CRIMINAL PENALTIES, AND UP TO \$25,000 IN MISDEMEANOR CRIMINAL PENALTIES FOR EACH VIOLATION.

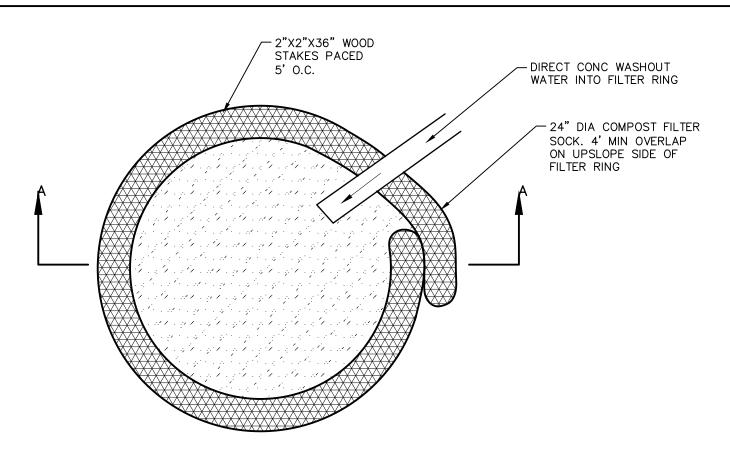

PLAN VIEW

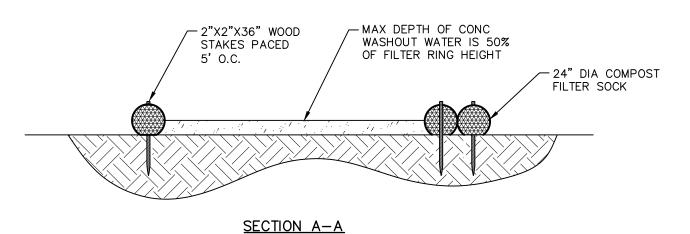

### NOTE

- 1. INSTALL ON FLAT GRADE FOR OPTIMUM PERFORMANCE.
- 18" DIAMETER FILTER SOCK MAY BE STACKED ONTO DOUBLE 24" DIAMETER SOCKS IN PYRAMIDAL CONFIGURATION FOR ADDED HEIGHT.
- 3. A SUITABLE IMPERVIOUS GEOMEMBRANE SHALL BE PLACED AT THE LOCATION OF THE WASHOUT PRIOR TO INSTALLING THE SOCKS
- 4. ALL CONCRETE WASHOUT FACILITIES SHALL BE INSPECTED DAILY. DAMAGED OR LEAKING WASHOUTS SHALL BE DEACTIVATED AND REPAIRED OR REPLACED IMMEDIATELY.
- 5. ACCUMULATED MATERIALS SHALL BE REMOVED WHEN THEY REACH 75% CAPACITY.

## TYPICAL CONCRETE WASHOUT/COMPOST SOCK WASHOUT INSTALLATON

STANDARD DETAIL 3-18

DISTURBED AREA

SECTION

DISTURBED AREA

SECTION

EXISTING
CONTOUR

COMPOST
FILTER SOCK

UNDISTURBED AREA

2" X 2" WOODEN
STAKES PLACED
10 FT ON CENTER

-2" X 2" WOODEN STAKES

PLACED 10 FT ON CENTER

COMPOST FILTER SOCK-


BLOWN/PLACED ·

FILTER MEDIA

- SOCK FABRIC SHALL MEET STANDARDS OF TABLE 4.1 OF THE PA DEP EROSION CONTROL MANUAL. COMPOST SHALL MEET THE STANDARDS OF TABLE 4.2 OF THE PA DEP EROSION CONTROL MANUAL.
- 2. COMPOST FILTER SOCK SHALL BE PLACED AT EXISTING LEVEL GRADE. BOTH ENDS OF THE BARRIER SHALL BE EXTENDED AT LEAST 8 FEET UP SLOPE AT 45 DEGREES TO THE MAIN BARRIER ALIGNMENT. MAXIMUM SLOPE LENGTH ABOVE ANY BARRIER SHALL NOT EXCEED THAT SPECIFIED FOR THE SIZE OF THE SOCK AND THE SLOPE OF ITS TRIBUTARY AREA.
- 3. TRAFFIC SHALL NOT BE PERMITTED TO CROSS COMPOST FILTER SOCKS.
- 4. ACCUMULATED SEDIMENT SHALL BE REMOVED WHEN IT REACHES 1/2 THE ABOVE GROUND HEIGHT OF THE BARRIER AND DISPOSED IN THE MANNER DESCRIBED ELSEWHERE IN THE PLAN.
- COMPOST FILTER SOCKS SHALL BE INSPECTED WEEKLY AND AFTER EACH RUNOFF EVENT. DAMAGED SOCKS SHALL BE REPAIRED ACCORDING TO MANUFACTURER'S SPECIFICATIONS OR REPLACED WITHIN 24 HOURS OF INSPECTION.
- 6. BIODEGRADABLE COMPOST FILTER SOCKS SHALL BE REPLACED AFTER 6 MONTHS; PHOTODEGRADABLE SOCKS AFTER 1 YEAR. POLYPROPYLENE SOCKS SHALL BE REPLACED ACCORDING TO MANUFACTURER'S RECOMMENDATIONS.
- 7. UPON STABILIZATION OF THE AREA TRIBUTARY TO THE SOCK, STAKES SHALL BE REMOVED. THE SOCK MAY BE LEFT IN PLACE AND VEGETATED OR REMOVED. IN THE LATTER CASE, THE MESH SHALL BE CUT OPEN AND THE MULCH SPREAD AS A SOIL SUPPLEMENT.
- 8. ANTIDEGRADATION BEST AVAILABLE COMBINATION OF TECHNOLOGIES (ABACT) APPROVED.

COMPOST FILTER SOCK

STANDARD DETAIL 4-01

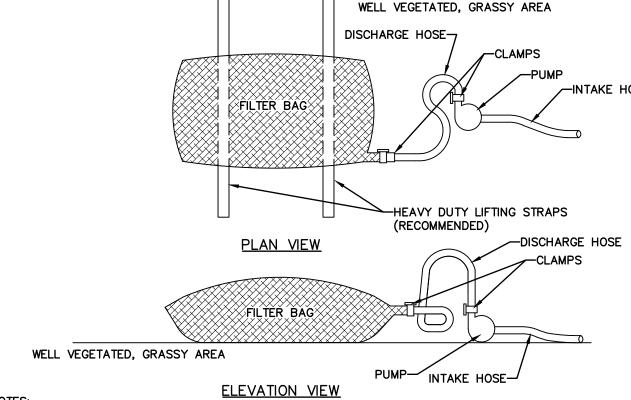

## ELEVATION VIEW


1. LOW VOLUME FILTER BAGS SHALL BE MADE FROM NON-WOVEN GEOTEXTILE MATERIAL SEWN WITH HIGH STRENGTH, DOUBLE STITCHED "J" TYPE SEAMS. THEY SHALL BE CAPABLE OF TRAPPING PARTICLES LARGER THAN 150 MICRONS. HIGH VOLUME FILTER BAGS SHALL BE MADE FROM WOVEN GEOTEXTILES THAT MEET THE FOLLOWING STANDARDS:


PROPERTY	TEST METHOD	MINIMUM STANDARD
AVG. WIDE WIDTH STRENGTH	ASTM D-4884	60 LB/IN
		· · · · · · · · · · · · · · · · · · ·
GRAB TENSILE	ASTM D-4632	205 LB
PUNCTURE	ASTM D-4833	110 LB
MULLEN BURST	ASTM D-3786	350 PSI
UV RESISTANCE	ASTM D-4355	70%
AOS % RETAINED	ASTM D-4751	80 SIEVE

- 2. A SUITABLE MEANS OF ACCESSING THE BAG WITH MACHINERY REQUIRED FOR DISPOSAL PURPOSES SHALL BE PROVIDED. FILTER BAGS SHALL BE REPLACED WHEN THEY BECOME 1/2 FULL OF SEDIMENT. SPARE BAGS SHALL BE KEPT AVAILABLE FOR REPLACEMENT OF THOSE THAT HAVE FAILED OR ARE FILLED. BAGS SHALL BE PLACED ON STRAPS TO FACILITATE REMOVAL UNLESS BAGS COME WITH LIFTING STRAPS ALREADY ATTACHED.
- BAGS SHALL BE LOCATED IN WELL-VEGETATED (GRASSY) AREA, AND DISCHARGE ONTO STABLE, EROSION RESISTANT AREAS. WHERE THIS IS NOT POSSIBLE, A GEOTEXTILE UNDERLAYMENT AND FLOW PATH SHALL BE PROVIDED. BAGS MAY BE PLACED ON FILTER STONE TO INCREASE DISCHARGE CAPACITY. BAGS SHALL NOT BE PLACED ON SLOPES GREATER THAN 5%. FOR SLOPES EXCEEDING 5%, CLEAN ROCK OR OTHER NON-ERODIBLE AND NON-POLLUTING MATERIAL MAY BE PLACED UNDER THE BAG TO REDUCE SLOPE STEEPNESS.
- NO DOWNSLOPE SEDIMENT BARRIER IS REQUIRED FOR MOST INSTALLATIONS. COMPOST BERM OR COMPOST FILTER SOCK SHALL BE INSTALLED BELOW BAGS LOCATED IN HQ OR EV WATERSHEDS, WITHIN 50 FEET OF ANY RECEIVING SURFACE WATER OR WHERE GRASSY AREA IS NOT AVAILABLE.
- 5. THE PUMP DISCHARGE HOSE SHALL BE INSERTED INTO THE BAGS IN THE MANNER SPECIFIED BY THE MANUFACTURER AND SECURELY CLAMPED. A PIECE OF PVC PIPE IS RECOMMENDED FOR THIS PURPOSE.
- 6. THE PUMPING RATE SHALL BE NO GREATER THAN 750 GPM OR 1/2 THE MAXIMUM SPECIFIED BY THE MANUFACTURER, WHICHEVER IS LESS. PUMP INTAKES SHALL BE FLOATING AND SCREENED.
- 7. FILTER BAGS SHALL BE INSPECTED DAILY. IF ANY PROBLEM IS DETECTED, PUMPING SHALL CEASE IMMEDIATELY AND NOT RESUME UNTIL THE PROBLEM IS CORRECTED.
- 8. ANTIDEGRADATION BEST AVAILABLE COMBINATION OF TECHNOLOGIES (ABACT) APPROVED IF SURROUNDED

PUMPED WATER FILTER BAG

STANDARD DETAIL 3-16

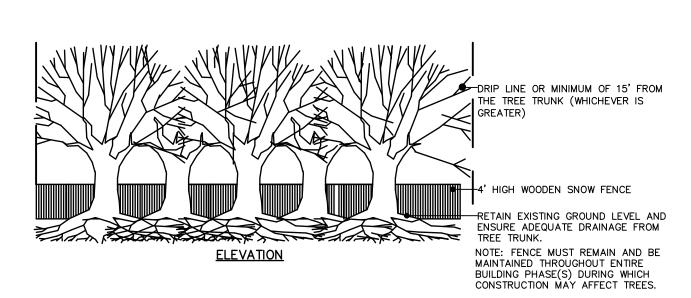

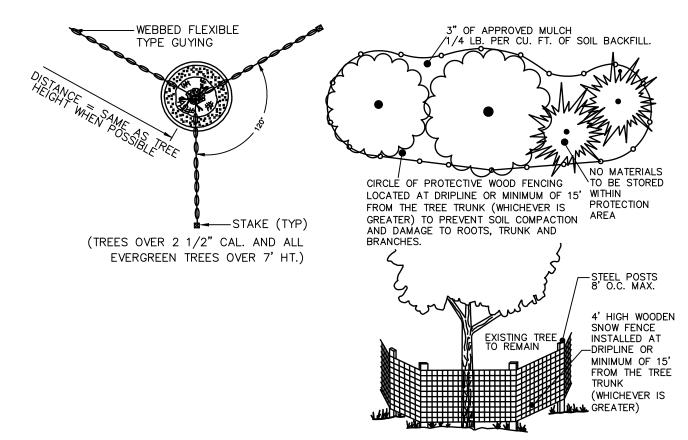

TREE PROTECTION DETAIL

Carroll Engineering Corporation


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433 Lancaster Avenue, Suite 200
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101 Larry Holmes Drive, Suite 20
Easton, PA 1804
Phone: 610-989-494

www.carrollengineering.com

King of Prussia, PA 19406



Y, PENNSYLVANIA

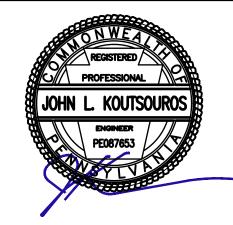O OLD YORK ROAD
SITUATED IN
H, MONTGOMERY COUNTY, PER
PREPARED FOR
ANAGEMENT SERVICES, INC.

610 OL S JENKINTOWN BOROUGH, MO PR

LAND DEVELOPMENT RESUBMISSION CML

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16 SHEETS

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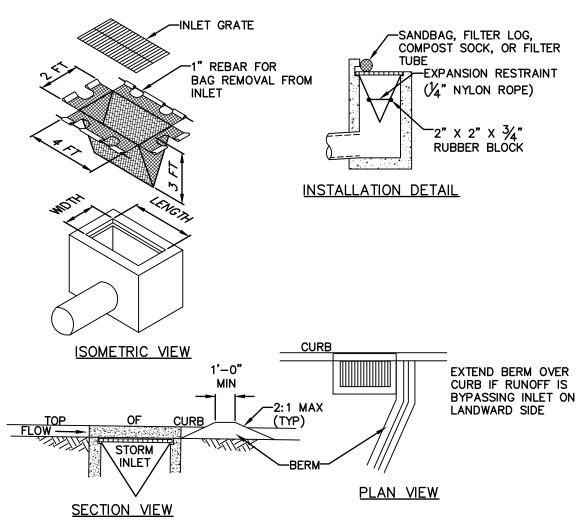
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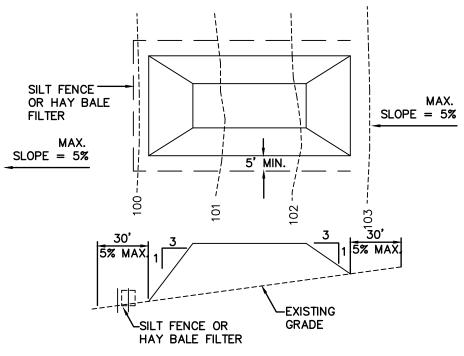
CJ-501



- 1. MAXIMUM DRAINAGE AREA = 1/2 ACRE.
- 2 INLET PROTECTION SHALL NOT BE REQUIRED FOR INLET TRIBUTARY TO SEDIMENT BASIN OR TRAP. BERMS SHALL BE REQUIRED FOR ALL INSTALLATIONS.
- 3. ROLLED EARTHEN BERM SHALL BE MAINTAINED UNTIL ROADWAY IS STONED. ROAD SUBBASE BERM SHALL BE MAINTAINED UNTIL ROADWAY IS PAVED. SIX INCH MINIMUM HEIGHT ASPHALT BERM SHALL BE MAINTAINED UNTIL ROADWAY SURFACE RECEIVES FINAL COAT. AT A MINIMUM, THE FABRIC SHALL HAVE A MINIMUM GRAB TENSILE STRENGTH OF 120 LBS, A MINIMUM BURST STRENGTH OF 200 PSI, AND A MINIMUM TRAPEZOIDAL TEAR STRENGTH OF 50 LBS. FILTER BAGS SHALL BE CAPABLE OF TRAPPING ALL PARTICLES NOT PASSING A NO. 40 SIEVE.
- 4. INLET FILTER BAGS SHALL BE INSPECTED ON A WEEKLY BASIS AND AFTER EACH RUNOFF EVENT. BAGS SHALL BE EMPTIED AND RINSED OR REPLACED WHEN HALF FULL OR WHEN FLOW CAPACITY HAS BEEN REDUCED SO AS TO CAUSE FLOODING OR BYPASSING OF THE INLET. DAMAGED OR CLOGGED BAGS SHALL BE REPLACED. A SUPPLY SHALL BE MAINTAINED ON SITE FOR REPLACEMENT OF BAGS. ALL NEEDED REPAIRS SHALL BE INITIATED IMMEDIATELY AFTER THE INSPECTION. DISPOSE OF ACCUMULATED SEDIMENT AS WELL AS ALL USED BAGS ACCORDING TO THE PLAN NOTES.
- 5. DO NOT USE ON MAJOR PAVED ROADWAYS WHERE PONDING MAY CAUSE TRAFFIC HAZARDS.
- 6. ANTIDEGRADATION BEST AVAILABLE COMBINATION OF TECHNOLOGIES (ABACT) APPROVED.


FILTER BAG INLET PROTECTION - TYPE C INLET

STANDARD DETAIL 4-15



- 1. PLACE STOCKPILES AT LOCATIONS AS SHOWN ON THE SOIL EROSION AND SEDIMENT CONTROL PLAN.
- 2. ALL SIDE SLOPES SHALL BE 3 TO 1 OR FLATTER.
- 3. STOCKPILE SHALL RECEIVE A VEGETATIVE COVER IN ACCORDANCE WITH MINIMUM
- 4. COMPOST FILTER SOCK, SILT FENCE OR HAY BALE FILTER SHALL BE INSTALLED AS DETAILED HEREON.


TOPSOIL STOCKPILE

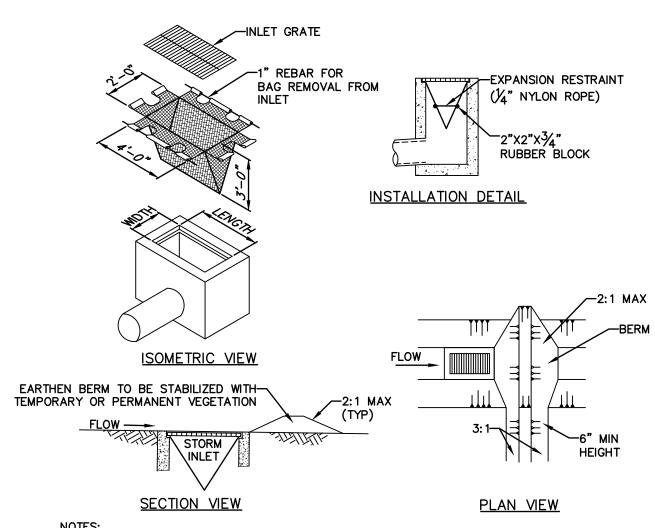

- 2. INLET PROTECTION SHALL NOT BE REQUIRED FOR INLET TRIBUTARY TO SEDIMENT BASIN
- 3. ROLLED EARTHEN BERM IN ROADWAY SHALL BE MAINTAINED UNTIL ROADWAY IS STONED. ROAD SUBBASE BERM ON ROADWAY SHALL BE MAINTAINED UNTIL ROADWAY IS PAVED. EARTHEN BERM IN CHANNEL SHALL BE MAINTAINED UNTIL PERMANENT STABILIZATION IS
- LBS., A MINIMUM BURST STRENGTH OF 200 PSI, AND A MINIMUM TRAPEZOIDAL TEAR STRENGTH OF 50 LBS. FILTER BAGS SHALL BE CAPABLE OF TRAPPING ALL PARTICLES NOT PASSING A NO. 40 SIEVE.
- EVENT. BAGS SHALL BE EMPTIED AND RINSED OR REPLACED WHEN HALF FULL OR WHEN FLOW CAPACITY HAS BEEN REDUCED SO AS TO CAUSE FLOODING OR BYPASSING OF THE INLET. DAMAGED OR CLOGGED BAGS SHALL BE REPLACED. A SUPPLY SHALL BE MAINTAINED ON SITE FOR REPLACEMENT OF BAGS. ALL NEEDED REPAIRS SHALL BE INITIATED IMMEDIATELY AFTER THE INSPECTION. DISPOSE ACCUMULATED SEDIMENT AS WELL AS ALL USED BAGS ACCORDING TO THE PLAN NOTES.
- 6. DO NOT USE ON MAJOR PAVED ROADWAYS WHERE PONDING MAY CAUSE TRAFFIC HAZARDS.
- 7. ANTIDEGRADATION BEST AVAILABLE COMBINATION OF TECHNOLOGIES (ABACT) APPROVED.
- FILTER BAG INLET PROTECTION-TYPE M INLET

STANDARD DETAIL 4-16



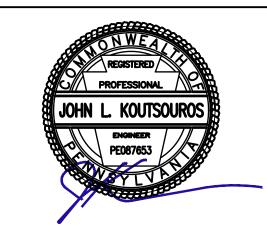

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DETAIL

CONTROL

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ROAD 10

6/19/2023

DATE CADD FILE JOB NO

CKD BY

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SCALE DRAWER NUMBER

DRAWING NUMBER CJ-502

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OF 16 SHEETS

1. MAXIMUM DRAINAGE AREA = 1/2 ACRE.


OR TRAP. BERMS SHALL BE REQUIRED FOR ALL INSTALLATIONS.


COMPLETED OR REMAIN PERMANENTLY.

4. AT A MINIMUM, THE FABRIC SHALL HAVE A MINIMUM GRAB TENSILE STRENGTH OF 120

5. INLET FILTER BAGS SHALL BE INSPECTED ON A WEEKLY BASIS AND AFTER EACH RUNOFF

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## STANDARD JENKINTOWN BOROUGH SIDEWALK CONSTRUCTION NOTES:

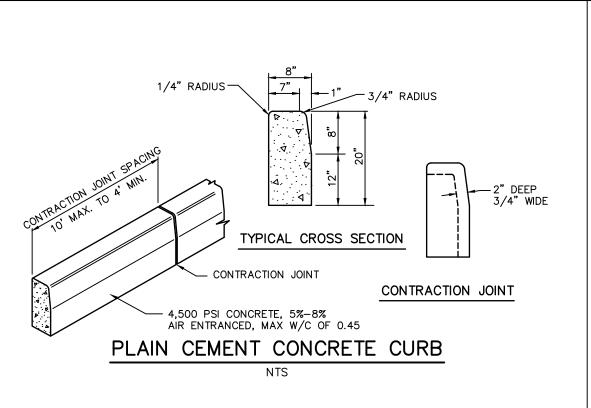ILL SIDEWALKS SHALL BE CONSTRUCTED BOTH AS TO MATERIALS AND METHODS, GENERALLY IN CONFORMANCE WITH APPLICABLE PORTIONS OF PENNDOT SPECIFICATIONS PUBLICATION 408, CURRENT EDITION, AND THE FOLLOWING STANDARDS:

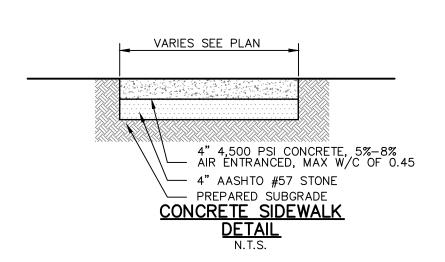EXCAVATION AND SUBBASE. WHEREVER SIDEWALK IS REPLACED OR INSTALLED, THE AREA UNDER THE SIDEWALK SHALL BE EXCAVATED TO A DEPTH OF EIGHT (8) INCHES BELOW THE LEVEL OF THE FINISHED SIDEWALK. FOUR (4) INCHES OF AASHTO # 57 STONE SHALL BE PLACED AND COMPACTED N THE EXCAVATED AREA UNDER THE SIDEWALK.

WOOD OR METAL FORMS MAY BE UTILIZED IN SIDEWALK CONSTRUCTION SO LONG AS THE FORMS ARE SET IN A FASHION THAT ENSURES THE THICKNESS OF THE SIDEWALK IS A FULL FOUR 4) INCHES. FORMS MUST BE INSPECTED BY THE BOROUGH OFFICIAL PRIOR TO CONCRETE BEING POURED.

EXPANSION JOINTS SHALL BE PLACED EVERY 30 FEET, WITH CONTRACTION JOINTS EVERY FIVE (5) FEET AT A MINIMUM OF ONE (1) INCH IN DEPTH. ADDITIONAL EXPANSION MATERIALS SHALL BE PLACED BETWEEN ANY CURB AND DRIVEWAY APRON AND IN THE SIDEWALK AT DRIVEWAY LIMITS. A CONTRACTION JOINT SHALL BE CUT BETWEEN THE SIDEWALK AND DRIVEWAY APRON.

THE SURFACE OF ALL SIDEWALKS SHALL HAVE A BROOM FINISH, UNLESS OTHERWISE APPROVED BY THE BOROUGH OF JENKINTOWN. THE EDGES OF ALL SIDEWALKS SHALL BE FINISHED WITH A 0.25 -INCH RADIUS AND JOINTS TROWELED EVERY FOUR (4) FEET OR SIX (6) FEET, UNLESS OTHERWISE APPROVED BY THE BOROUGH OF JENKINTOWN.

AS SOON AS REASONABLY POSSIBLE, BUT IN NO EVENT MORE THAN 12 HOURS AFTER THE REMOVAL OF FORMS, ANY VOID BEHIND THE SIDEWALK SHALL BE BACKFILLED. MATERIAL SHALL BE PLACED IN LOOSE LAYERS NOT EXCEEDING FOUR (4) INCHES AND COMPACTED USING VIBRATING OR IMECHANICAL TAMPERS. THE TOPMOST FOUR (4) INCHES SHALL BE TOPSOIL WHICH IS RAKED AND SEEDED FOR AREAS WHERE A GRASS STRIP IS TO ADJOIN THE CURB. NEW SEED SHALL BE WATERED WITHIN 24 HOURS OF INITIAL PLACEMENT. WHERE THERE ARE SLOPES ADJACENT TO A SIDEWALK IN EXCESS OF 25%, MATTING IS REQUIRED.

AN OPENING SHALL BE LEFT AROUND ALL TREES WITHIN THE SIDEWALK AREA. ALL POLES, FIRE HYDRANTS, LIGHT STANDARDS, OR ANY OTHER STRUCTURE SHALL HAVE AN AREA OF CONCRETE / MINIMUM OF SIX (6) INCHES LARGER THAN THE PERTINENT ITEM, BOXED OUT WITH AN EXPANSION JOINT. SIGNPOST SLEEVES SHALL BE PROVIDED FOR EXISTING AND PROPOSED SIGNS.

NO ACCUMULATED SURFACE, ROOF AREA, OR DRIVEWAY RUNOFF SHALL BE DIRECTED ACROSS THE SURFACE OF A SIDEWALK. ALL SIDEWALK AND CURB CONSTRUCTION SHALL ACCOMMODATE DRAINAGE OF SURFACE, ROOF AREA, AND DRIVEWAY RUNOFF UNDER THE SIDEWALK WHERE NECESSARY.

UNDER NO CIRCUMSTANCES SHALL ANY PUBLIC SERVICE CURB OR SIDEWALK BOXES FOR ACCESS TO UNDERGROUND FACILITIES BE LEFT BELOW THE SIDEWALK LEVEL. SERVICE CURB OR SIDEWALK

BOXES SHALL BE EXTENDED TO THE FINISHED ELEVATION OF THE NEW SIDEWALK. -SUPERPAVE ASPHALT MIXTURE DESIGN, HMA BINDER COURSE, PG 64-22, 3 TO <10 SUPERPAVE ASPHALT-MILLION ESALS, 19.0 MM MIX 2.5" DEPTH MIXTURE DESIGN, HMA WEARING COURSE, PG SUPERPAVE ASPHALT MIXTURE DESIGN, HMA 64-22, 3 TO <10 BASE COURSE (BCBC), PG 64-22, 3 TO <10 MILLION ESALS, 9.5 MM MILLION ESALS, 25.0 MM MIX 5.5" DEPTH\* MIX, 1.5" DEPTH, SRL-H -SAW CUT EDGE OR MILL & SEAL WITH HOT BITUMINOUS MATERIAL (AC-20) 12" WIDE MIN (TYP.) -#2A COARSE AGGREGATE, 6" DEPTH - RECOMPACT SURFACE OF TRENCH BACKFILL

- 1. SPECIAL CONDITIONS OF ROAD OPENING PERMIT MAY SUPERSEDE THIS DETAIL.
- EXPOSED VERTICAL AND HORIZONTAL SURFACES SHALL BE PREPARED AS PER PUB 408, SECTION 40J. 3(F)
- OVER CUT ALL EDGES 1'. EXCAVATE OLD AND TEMPORARY MATERIAL. RECOMPACT SUB-GRADE. TACK COAT ALL VERTICAL EDGES. INSTALL ONLY
- BASE COURSE AND BINDER IN ONE DAY. \* MATCH EXISTING DEPTH IF GREATER

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## PERMANENT PAVEMENT RESTORATION

STANDARD JENKINTOWN BOROUGH CURB CONSTRUCTION NOTES:

ALL CURBING SHALL BE CONSTRUCTED BOTH AS TO MATERIALS AND METHODS, GENERALLY IN CONFORMANCE WITH APPLICABLE PORTIONS OF PENNDOT SPECIFICATIONS PUBLICATION 408, CURRENT EDITION, AND THE FOLLOWING STANDARDS:

THE CURB AREA SHALL BE EXCAVATED TO THE REQUIRED DEPTH. THE MATERIAL UPON WHICH THE CURB WILL BE CONSTRUCTED SHALL BE

COMPACTED TO A FIRM, UNIFORM AND EVEN SURFACE. IN SITUATIONS DEEMED DUE TO EXISTING GRADE OR GROUND CONDITIONS, AND IN ACCORDANCE WITH INDUSTRY STANDARDS, THE BOROUGH OFFICIAL MAY REQUIRE AN ADDITIONAL EIGHT (8) INCHES OF SUBSOIL EXCAVATED. WHICH SHALL BE BACKFILLED AND TAMPED WITH

FORMS SHALL NOT DISCOLOR THE CONCRETE. ALL CURBS SHALL BE CONSTRUCTED AND RECONSTRUCTED USING THE STEEL CURB AND RADIUS FORMS SPECIFIED IN PENNDOT PUB. 408, AS MOST RECENTLY REVISED.

FORMS SHALL NOT BE REMOVED FOR AT LEAST 12 HOURS IN THE PERIOD FROM APRIL 15 TO OCTOBER 15, OR FOR AT LEAST 24 HOURS DURING THE REST OF THE YEAR. IN NO EVENT SHALL THE FORMS BE PERMITTED TO REMAIN IN PLACE FOR MORE THAN 48 HOURS. DIVISION PLATES OR FORM OR SAWCUT CONTRACTION JOINTS 3/ 16 INCH WIDE AND TWO (2) INCHES DEEP SHALL BE UTILIZED EVERY 10 FEET. ANY SAW CONTRACTION JOINT SHALL BE SAWN AS SOON AS POSSIBLE AFTER THE CONCRETE HAS SET SUFFICIENTLY TO PRECLUDE

THE DEPTH OF THE SAW CUT MAY BE DECREASED AT THE EDGE ADJACENT TO THE PAVEMENT TO OBTAIN A MAXIMUM DEPTH WITHOUT PAVEMENT DAMAGE.

THE EDGES OF CONTRACTION JOINTS SHALL BE ROUNDED TO A 0.25 -INCH RADIUS.

RAVELING DURING THE SAWING AND BEFORE ANY SHRINKAGE CRACKING OCCURS IN THE CONCRETE

CRUSHED STONE BEFORE CONSTRUCTION OF THE CURB.

0.5 -INCH PRE -MOLDED EXPANSION JOINT MATERIAL SHALL BE CUT TO THE CROSS-SECTIONAL AREA OF THE CURB, AT STRUCTURES, AND SHALL BE PLACED AT THE END OF EACH WORK DAY.

CONCRETE SHALL BE POURED IN THE FORMS IN LAYERS NOT EXCEEDING FIVE (5) INCHES IN DEPTH; PROVIDED, HOWEVER, THAT WHEN USING A VIBRATOR TO ELIMINATE VOIDS, CONCRETE MAY BE POURED IN LAYERS UP TO 15 INCHES IN DEPTH.


UPON REMOVAL OF FORMS, ANY IRREGULAR SURFACES SHALL BE CORRECTED, PREFERABLY BY RUBBING THE IRREGULAR SURFACE WITH A CARBORUNDUM STONE. THE FACE OF CURB SHALL HAVE A SMOOTH, RUBBED SURFACE TO THE GUTTER LINE. BRUSH -FINISHING OR PLASTERING WILL NOT BE PERMITTED. MINOR DEFECTS MAY BE FILLED WITH MORTAR. NO VOIDS OR HONEYCOMB SHALL BE PERMITTED ON THE FINISHED SURFACES OF THE CURB. THE TOP SURFACE OF THE CURB SHALL BE SMOOTH AND EVENLY FINISHED, PREFERABLY USING A WOOD FLOAT. WHILE THE CONCRETE IS STILL PLASTIC, THE EDGES OF THE FACE AND BACK OF THE CURB SHALL BE ROUNDED.


AS SOON AS POSSIBLE AFTER THE REMOVAL OF THE FORMS, BUT IN NO EVENT MORE THAN 12 HOURS AFTER THE REMOVAL OF THE FORM, ANY VOID BEHIND THE CURB SHALL BE BACKFILLED. THE EXCAVATED AREA SHALL BE FILLED WITH AASHTO # 57 STONE TO SIX (6) INCHES BELOW THE LEVEL OF FINISH GRADE. SIX ( 6) INCHES OF TOPSOIL SHALL BE PLACED ON TOP OF THE STONE, AND THE AREA SHALL BE RAKED AND SEEDED. NEW SEED MUST BE WATERED WITHIN 24 HOURS AFTER INITIAL PLACEMENT.


UPON WRITTEN APPROVAL BY THE BOROUGH OFFICIAL, CURB MAY BE PLACED WITH A SELF-PROPELLED MACHINE, PROVIDED THAT THE CONCRETE PLACED WITH THE SELF-PROPELLED MACHINE MAINTAINS ITS SHAPE WITHOUT SLUMPING AFTER EXTRUSION AND THAT THE CURB IS FINISHED IN ACCORDANCE WITH THE PROVISIONS SET FORTH HEREIN.

ALTERNATIVELY, GRANITE BLOCKS MAY BE UTILIZED AS CURBING ALONG ROADS AND WITHIN PARKING TOTS NOT BEING DEDICATED TO THE BOROUGH.


A RADIUS CURB SHALL BE CONSTRUCTED AT ALL INTERSECTIONS. INCLUDING INTERSECTIONS BETWEEN PUBLIC OR PRIVATE ALLEYS AND A STREET. THE MINIMUM RADIUS FOR ANY CURB AT A STREET INTERSECTION SHALL BE 10 FEET. THE MINIMUM RADIUS FOR ANY CURB AT AN INTERSECTION BETWEEN TWO ALLEYS, WHERE APPLICABLE, OR AN ALLEY AND A STREET, SHALL BE FIVE (5) FEET. RADIUS CURBS AND WALKS SHALL BE POURED MONOLITHICALLY FROM THE POINT OF CURVATURE TO POINT OF TANGENT.

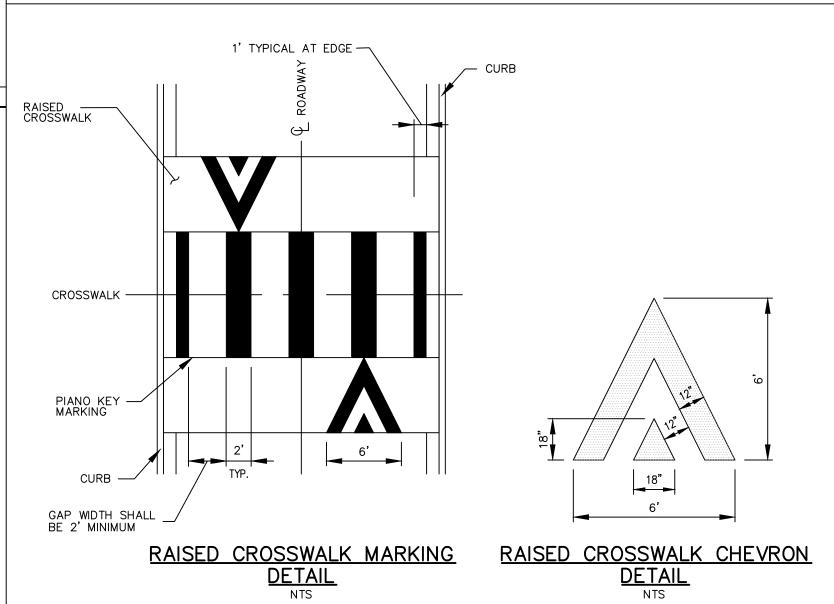


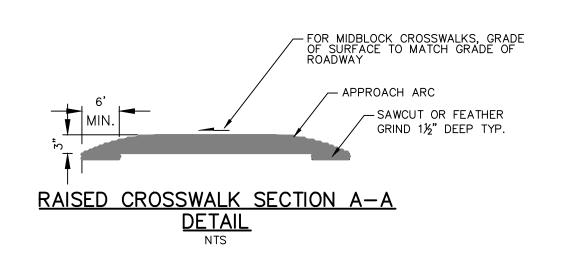

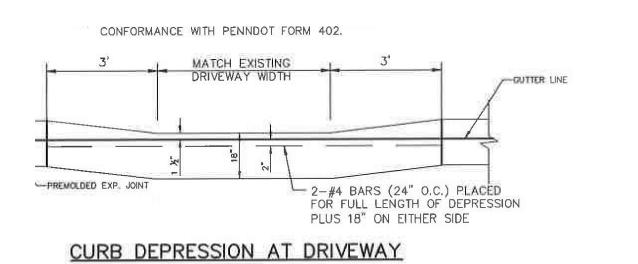


NOT TO SCALE

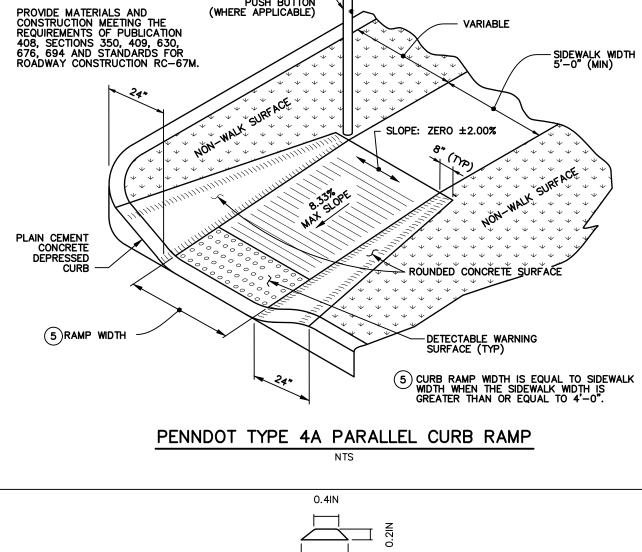


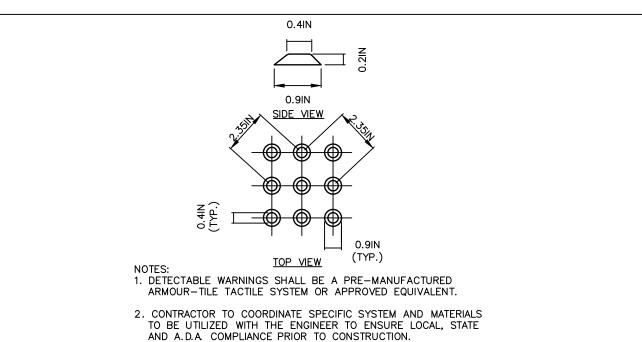



## TRUNCATED DOME PATTERN FOR A.D.A. DETECTABLE WARNING SURFACES

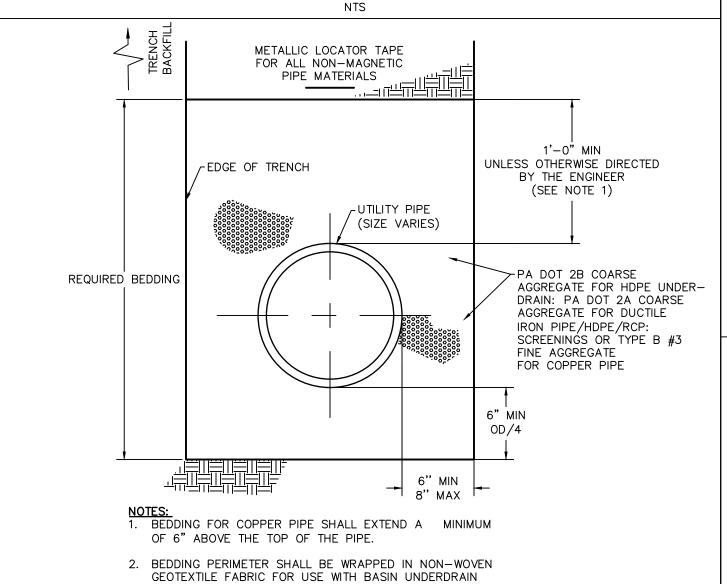


## STANDARD PIPE BEDDING

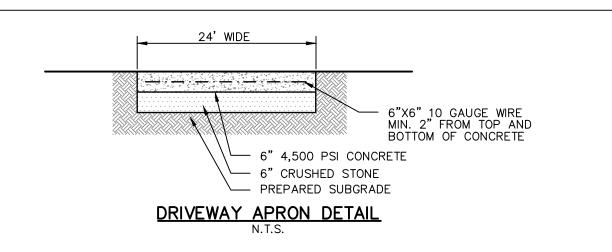


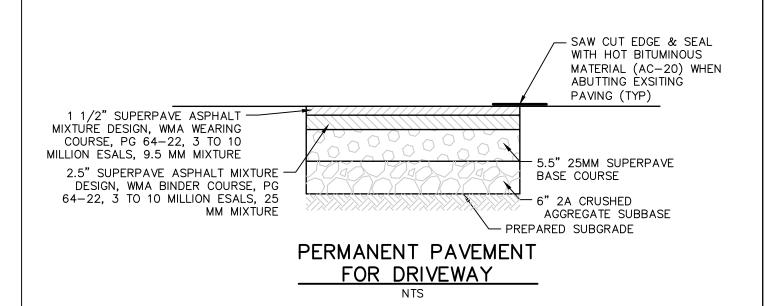


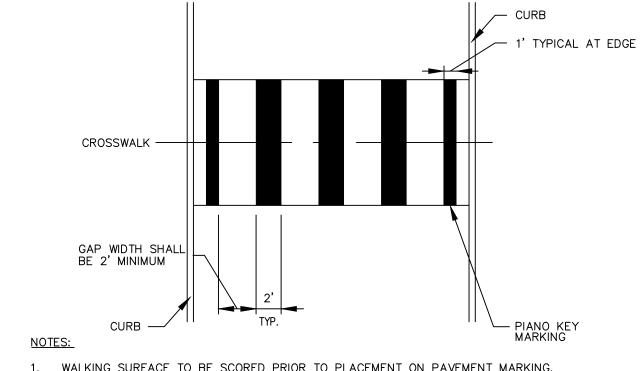

WALKING SURFACE TO BE SCORED PRIOR TO PLACEMENT ON PAVEMENT MARKING. CROSSWALK MARKING DETAIL

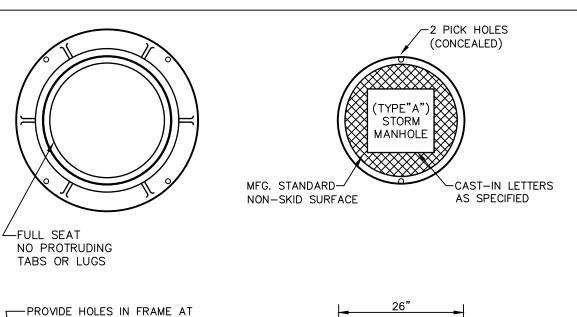


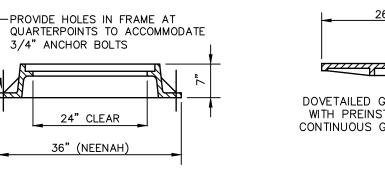

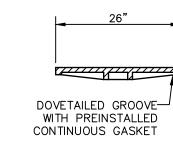

- MANHOLE FRAME AND COVER SHALL BE NEENAH FOUNDRY CO. MODEL R-1642, WITH SELF-SEALING LID GASKET (OR APPROVED EQUAL).
- 2. ALL MATERIALS TO BE GRAY CAST IRON ASTM A-48, CLASS 35.
- 3. FRAME AND COVER SHALL BE FOR HEAVY DUTY TRAFFIC, AASHTO HS-20. 4. PROVIDE FOUR (4) STAINLESS STEEL ANCHOR BOLTS, 3/4" DIA. MINIMUM.
- COVER SHALL HAVE THE WORDS "BCWSA SANITARY SEWER" OR "BCWSA 'S' DANGER KEEP OUT" CAST THEREON IN 2" LETTERS.
- 6. FRAME AND COVER SHALL BE COATED WITH BLACK ASPHALTIC PAINT.
- THE FOLLOWING MANUFACTURER'S STANDARD CASTING, OR APPROVED EQUAL, SHALL BE USED.

## STANDARD STORM MANHOLE FRAME AND COVER

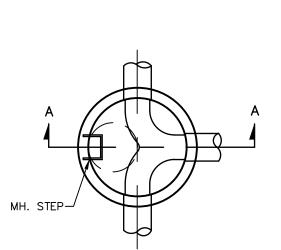

PLAN VIEW

PRECAST REINFORCED

PRECAST REINFORCED CONCRETE

12" MIN

SHELF

ECCENTRIC CONE SECTION —

┌3/4" INSERT

- WRAPID SEAL BY CANUSA

EXTERNAL CHIMNEY SEAL

(TYP)

SECTION A-A

(OR APPROVED EQUAL)

1. THE DEPTH OF THE INVERT CHANNEL SHALL BE EQUAL TO 3/4 OF THE DIAMETER OF THE SEWER. 2. THE SHELF SHALL SLOPE TOWARD THE INVERT

- CHANNEL AT A RATE OF 1" PER FOOT.
- 3. TYPE "B" MANHOLES (SHALLOW TYPE) TO BE PROVIDED WHERE REQUIRED BY DEPTH CONDITIONS. ALL OTHER MANHOLES TO BE TYPE "A".
- 4. FOR MANHOLES HAVING 5' DIA. AND 6' DIA. BASE, REDUCTION IN DIAMETER TO 4' SHALL START AT THE FIRST JOINT ABOVE THE UPPERMOST PIPE CONNECTION TO WALL, WHERE DEPTH IS SUFFICIENT.
- 5. ALL MANHOLE FRAMES SHALL BE BOLTED TO THE CONE SECTION OR CONCRETE SLAB WITH (4)-3/4" DIA. BOLTS WITH WASHERS AND NUTS. BOLTS TO
- BE AT 90° ON THE BOLT CIRCLE. 6. SEE THE SPECIFICATIONS FOR LENGTH OF PIPE CONNECTIONS TO MANHOLES.
- 7. ALL CONCRETE SHALL BE 4000 PSI MINIMUM. 8. ENTIRE OUTSIDE SURFACE OF MANHOLE SHALL
- RECEIVE TWO COATS OF BITUMINOUS COATING, COAL TAR EPOXY, OR APPROVED EQUAL. 9. INSTALL DOUBLE RING OF PLASTIC BUTYL JOINT SEALANT BETWEEN ALL SECTIONS AND UNDER
- 10. MANHOLE CONSTRUCTION SHALL BE IN ACCORDANCE
- WITH ASTM C478. 11. PROVIDE A RESILIENT PIPE CONNECTION GASKET CAST INTEGRALLY IN MANHOLE WALL AT ALL PIPE CONNECTIONS. GASKET SHALL BE A-LOK CONNECTOR, OR APPROVED EQUAL. GROUT IN ACCORDANCE
- WITH MANUFACTURER'S RECOMMENDATIONS. 12. 4' DIA. MANHOLE - 8" TO 16" PIPES 5' DIA. MANHOLE - 18" TO 27" PIPES 6' DIA. MANHOLE - 30" TO 48" PIPES
- 13. AN EXTERNAL CHIMNEY SEAL SHALL BE INSTALLED OVER FRAME AND GRADE RINGS. CHIMNEY SEAL SHALL BE WRAPID SEAL BY CANUSA OR APPROVED EQUAL. 14. MANHOLES THAT RECEIVE FORCE MAIN DISCHARGE OR THAT ARE LOCATED ON INTERCEPTORS OR TRUNK SEWERS SHALL BE CONSTRUCTED WITH A SPRAY-ON POLYMETRIC LINING SYSTEM, SPECTRASHIELD, OBIC, OR APPROVED EQUAL.
- 15. SEE DETAIL S-7 OR S-8 FOR MANHOLE STEP REQUIREMENTS. 5" WALL FOR 4'-0" DIA. MH. 6" WALL FOR 5'-0" DIA. MH " WALL FOR 6'-0" DIA. MH.
- PRECAST REINFORCED


CONCRETE BASE -3/4 DIA OF -CONCRETE RISER LARGEST PIPE SECTION └4" MIN CONC. CHANNEL FILL MIN. 6" CRUSHED-

TYPE "A" STANDARD STORM SEWER MANHOLE Carroll Engineering Corporation

CORPORATE OFFIC

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6/19/2023 2211190108 221119

NTS

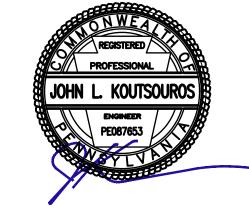16 SHEETS


CADD FILE JOB NO CML DWN BY CML JLK

CKD BY

DSG BY


SCALE DRAWER NUMBER SHEET


DRAWING NUMBER C - 501

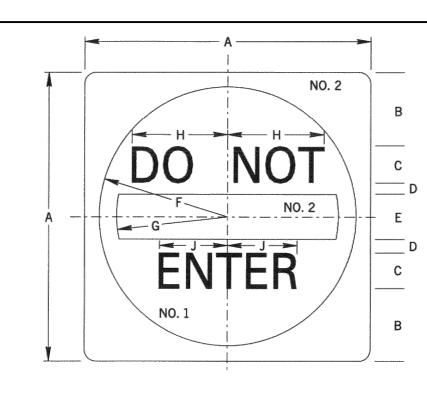


			DIM	ENSIO	VS – n	nm (IN	l)		
SIGN SIZE A x A	В	С	D	Е	F	G	Н	J	BLANK STD.
750 x 750 (30" x 30")	165 (6.6)	100D (4D)	47 (1.9)	126 (5)	365 (14.6)	310 (12.4)	251 (9.9)	199 (7.9)	B3- <b>75</b> 0 (B3-30)

## DO NOT ENTER DETAIL NTS

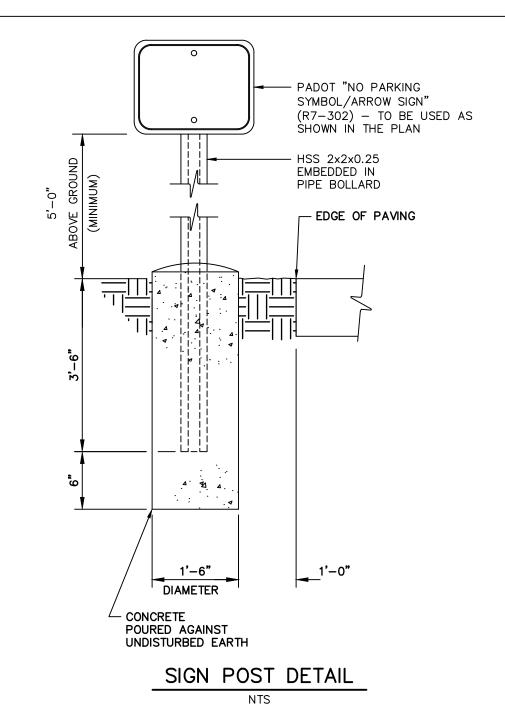


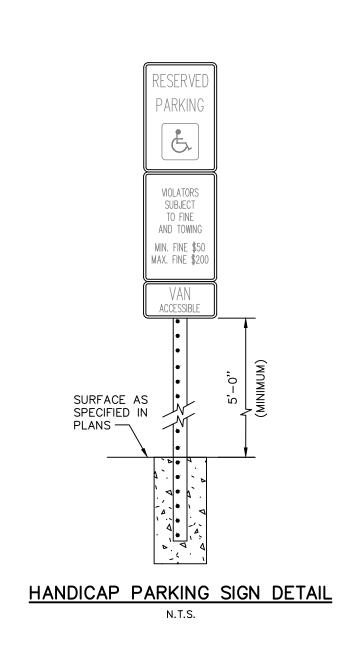

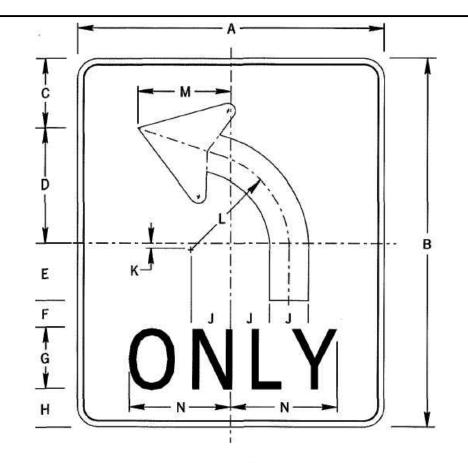


NOTE: SEE STANDARD ARROW FOR DIMENSIONS OF ARROWHEAD

SIGN SIZE A x B	С	D	E	F	G	Н	J	К	L	М	N	MAR- GIN	BOR- DER	BLANK STD.
30" x 36"	6.8	11.2	5.6	2.6	6D	3.8	3.8	0.6	9.5	9.1	10.1	0.6	0.8	B5-3630

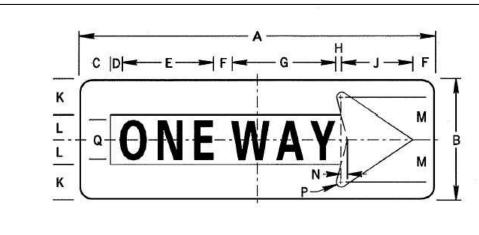


						D	IMEN	SIONS	11 – 6	¥.					
SIGN SIZE A x B	С	D	Е	F	G	Н	J	K	L	М	N	Р	Q	BOR- DER	BLANK STD.
36" x 12"	3	1.2	9.1*	2.2	10.6*	0.5	7.2	3.4	2.6	4.2	0.6	0.7	4D	0.4	B5-3612
54" x 18"	5	3	12.3	4	13.5	2.2	10	5.2	3.8	5.8	0.8	1	5D	0.8	<u> </u>

ONE-WAY SIGN DETAIL

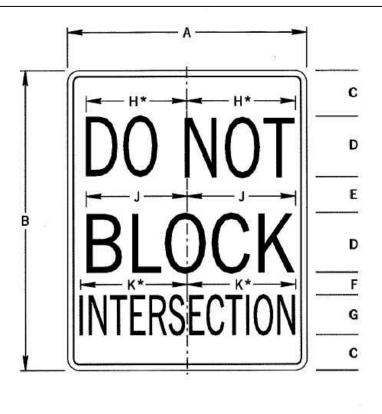

DIMENSIONS - IN											
SIGN SIZE A x B	С	D	E	F	G	Н	J	К	MAR- GIN	BOR- DER	BLANK STD.
24" x 30"	4	6C	3.6	2.4	4B	10.2	10.3	10.4	0.4	0.6	B5-3024

DO NOT BLOCK INTERSECTION SIGN DETAIL

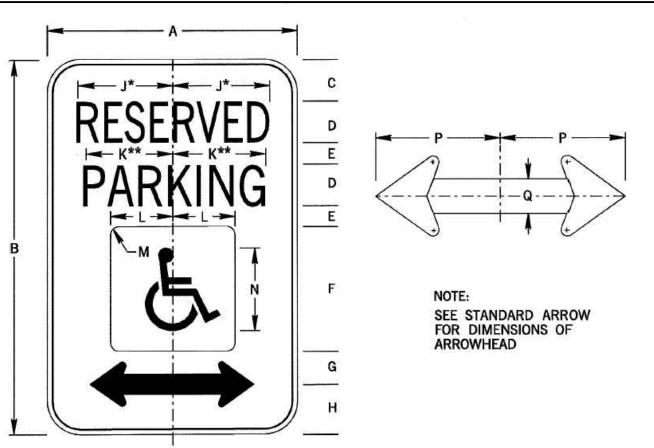


DIMENSIONS - IN																
SIGN SIZE A x B	С	D	E	F	G	Н	J	К	L	М	N	Р	Q	MAR- GIN	BOR- DER	BLANK STD.
12" x 18"	2	2C	1	6	1.6	2.4	4.9	4.3	3	0.4	4	3.8	8.0	0.4	0.4	B5-1218

\* REDUCE SPACING 50% \*\* REDUCE SPACING 33%




	DIMENSIONS - IN														
SIGN SIZE A x B	С	D	E	F	G	н	J	К	L	М	MAR- GIN	BOR- DER	BLANK STD.		
12" x 18"	3	1C	1	2	3	2.4	2.3	3.6	4	4.6	0.4	0.4	B5-1218		

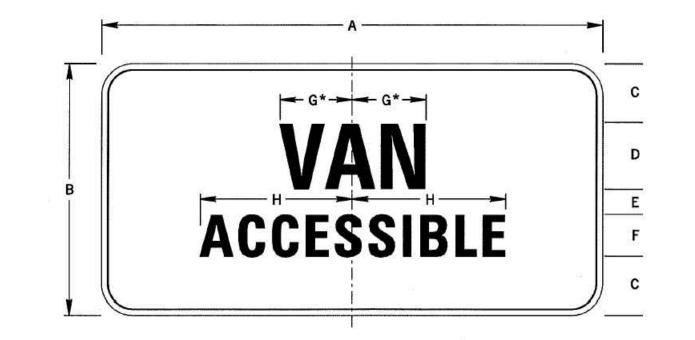

			D	IMENS	IONS -	IN			
SIGN SIZE A x B	С	D	E	F	G	Н	MAR- GIN	BOR- DER	BLANK STD.
12" x 6"	1.4	1.6D	0.6	1D	2.1	4	0.4	0.4	B5-1206


HANDICAP PARKING SIGN DETAIL

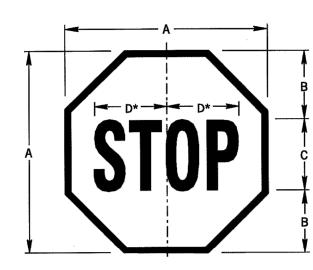

		DIMENSIO	ons – In		
SIGN SIZE A x A	В	С	D	BOR- DER	BLANK STD.
18" x 18"	6	6C	8	0.4	

STOP SIGN DETAIL

NTS

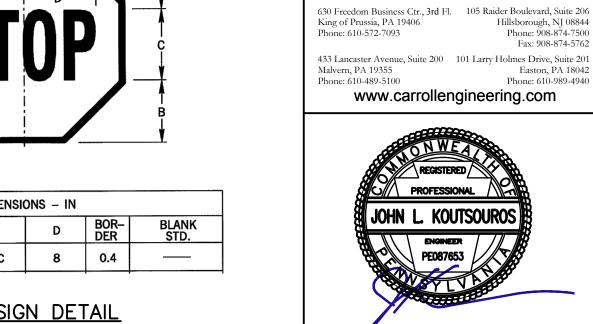

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ROAD


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SBG


CONSTRUCTION DETAILS


PHONE:

2 1 5 . 3 4 3 . 5 7 0

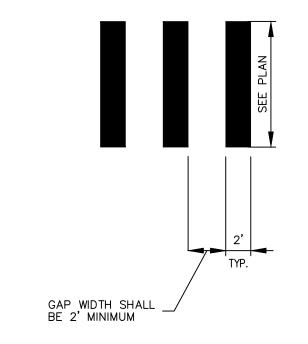


NOTES:
1. PAVEMENT MARKINGS TO BE LONG LIFE EPOXY AND SURFACE
TO BE SCORED TO BE DISTINGUISHED FROM PAVEMENT CROSSWALK MARKING DETAIL

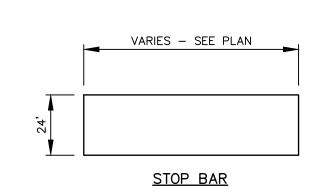

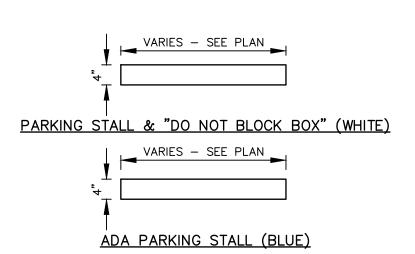


NOTES: 1. ALL PAVEMENT MARKINGS TO BE LONG LIFE EPOXY PAVEMENT MARKING DETAIL
N.T.S.

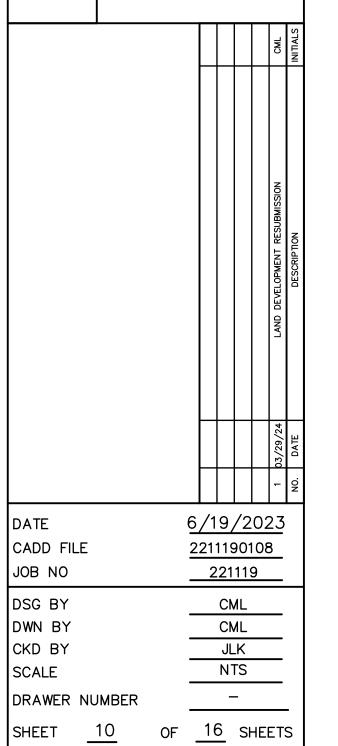


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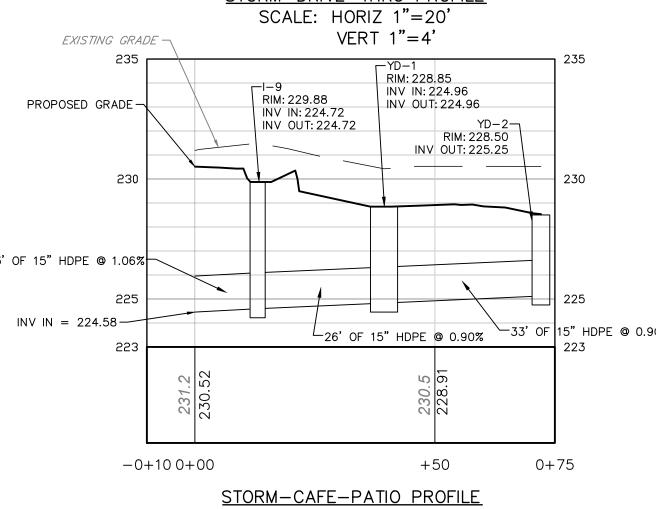
C-502

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PROPOSED GRADE RIM: 227.50 INV OUT: 224.58 66' OF 15" HDPE @ 5.23% INV IN = 221.14-0+10 0+00 +50 0 + 75STORM-DRIVE-THRU PROFILE

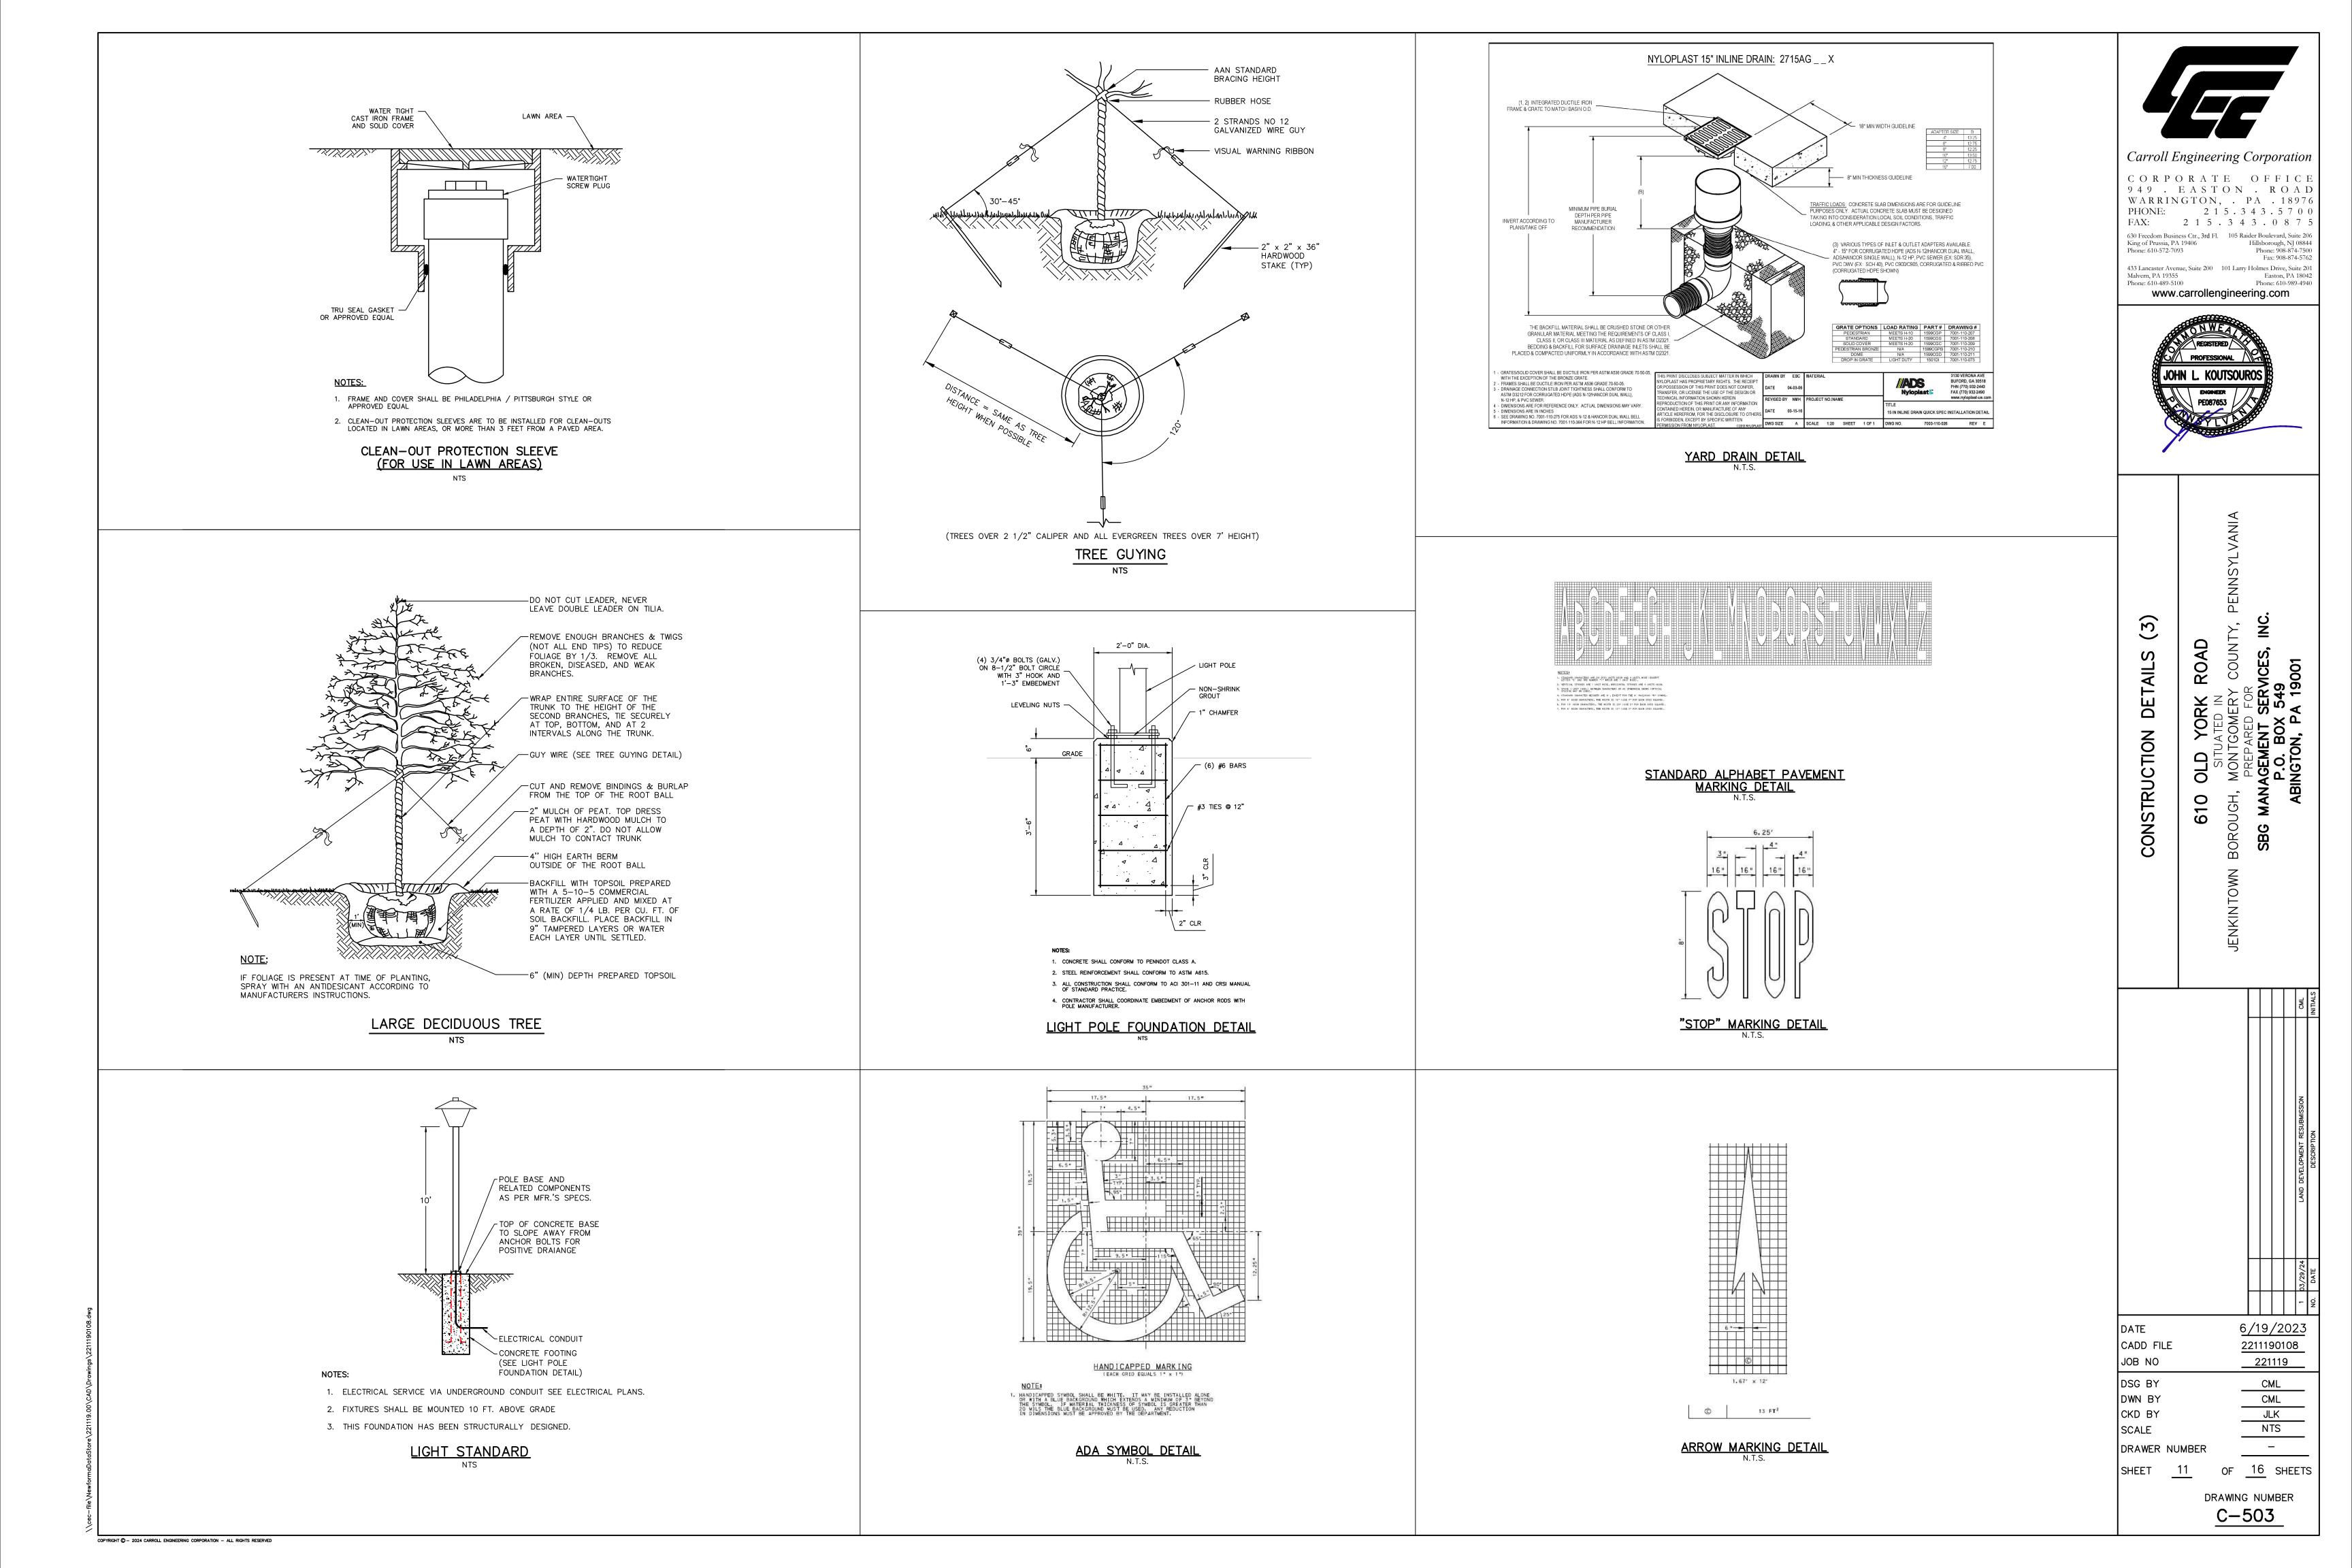

SCALE: HORIZ 1"=20'

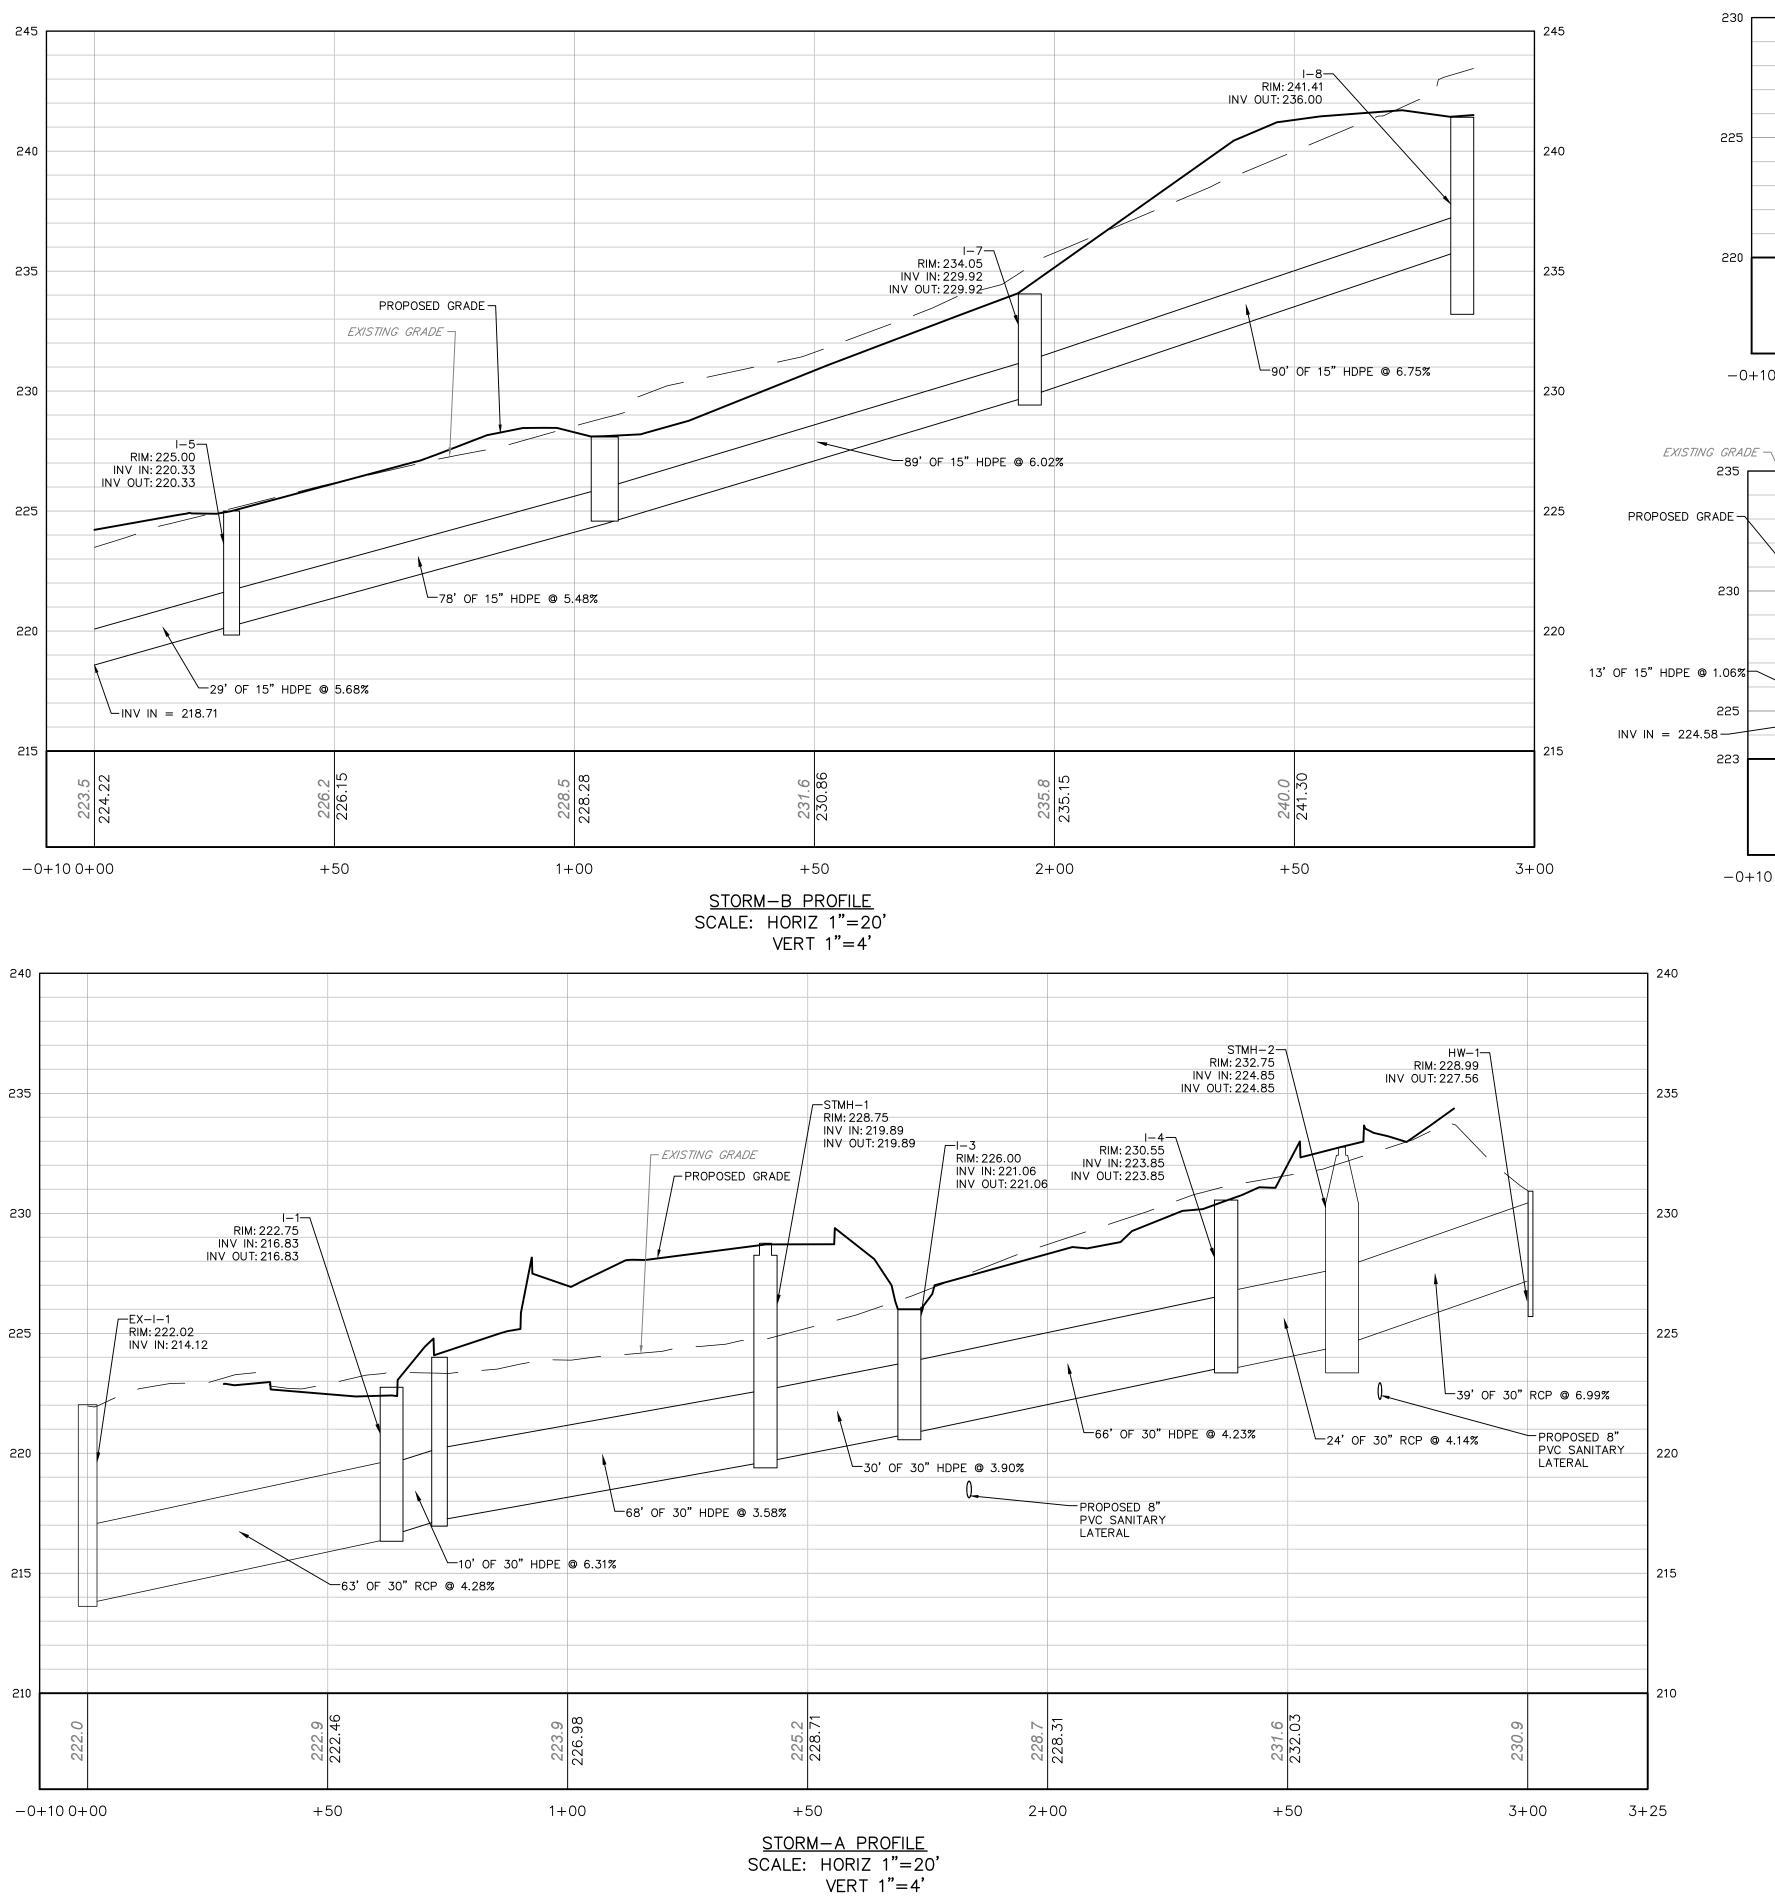VERT 1"=4'

ROAD 10

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JOHN L. KOUTSOURO

Fax: 908-874-5762

Easton, PA 18042

SBG

DATE CADD FILE JOB NO


2211190402 221119


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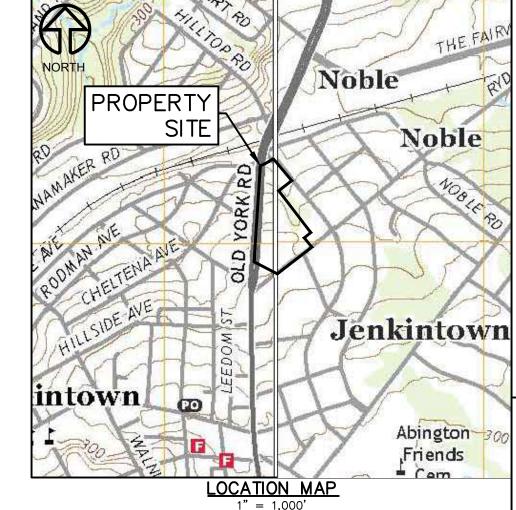
DSG BY DWN BY CKD BY SCALE

DRAWER NUMBER SHEET

OF 16 SHEETS DRAWING NUMBER C-103



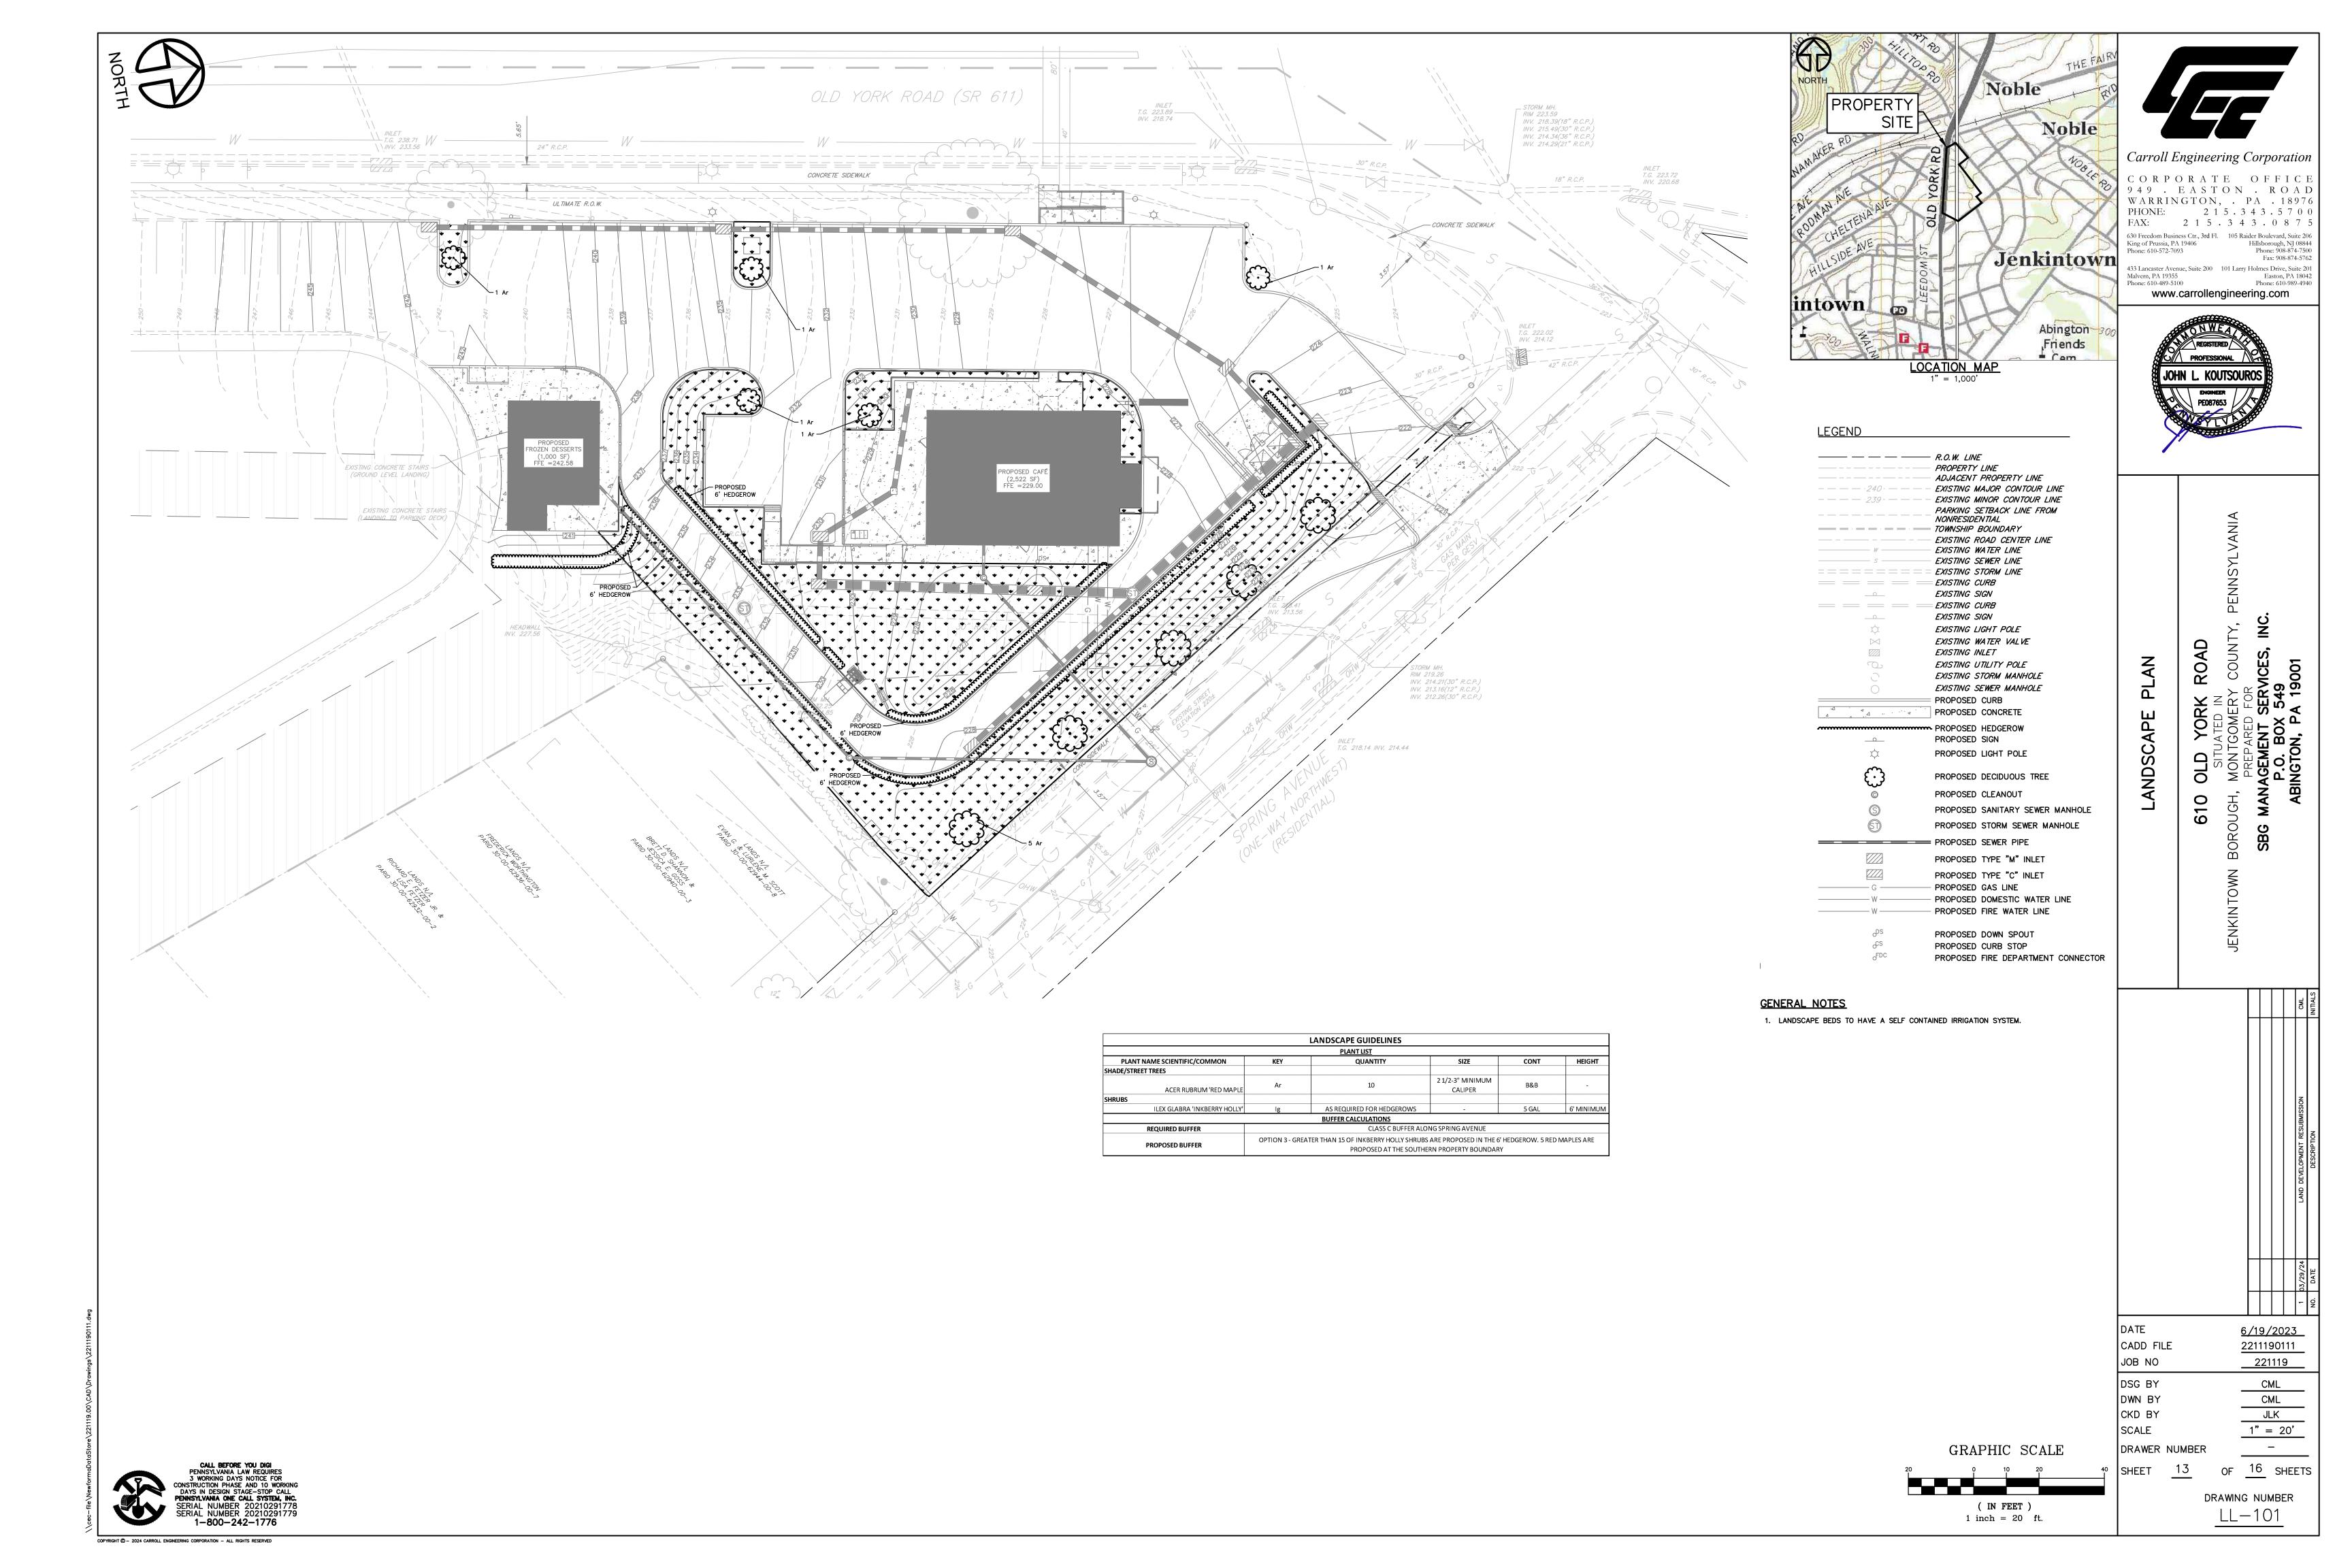

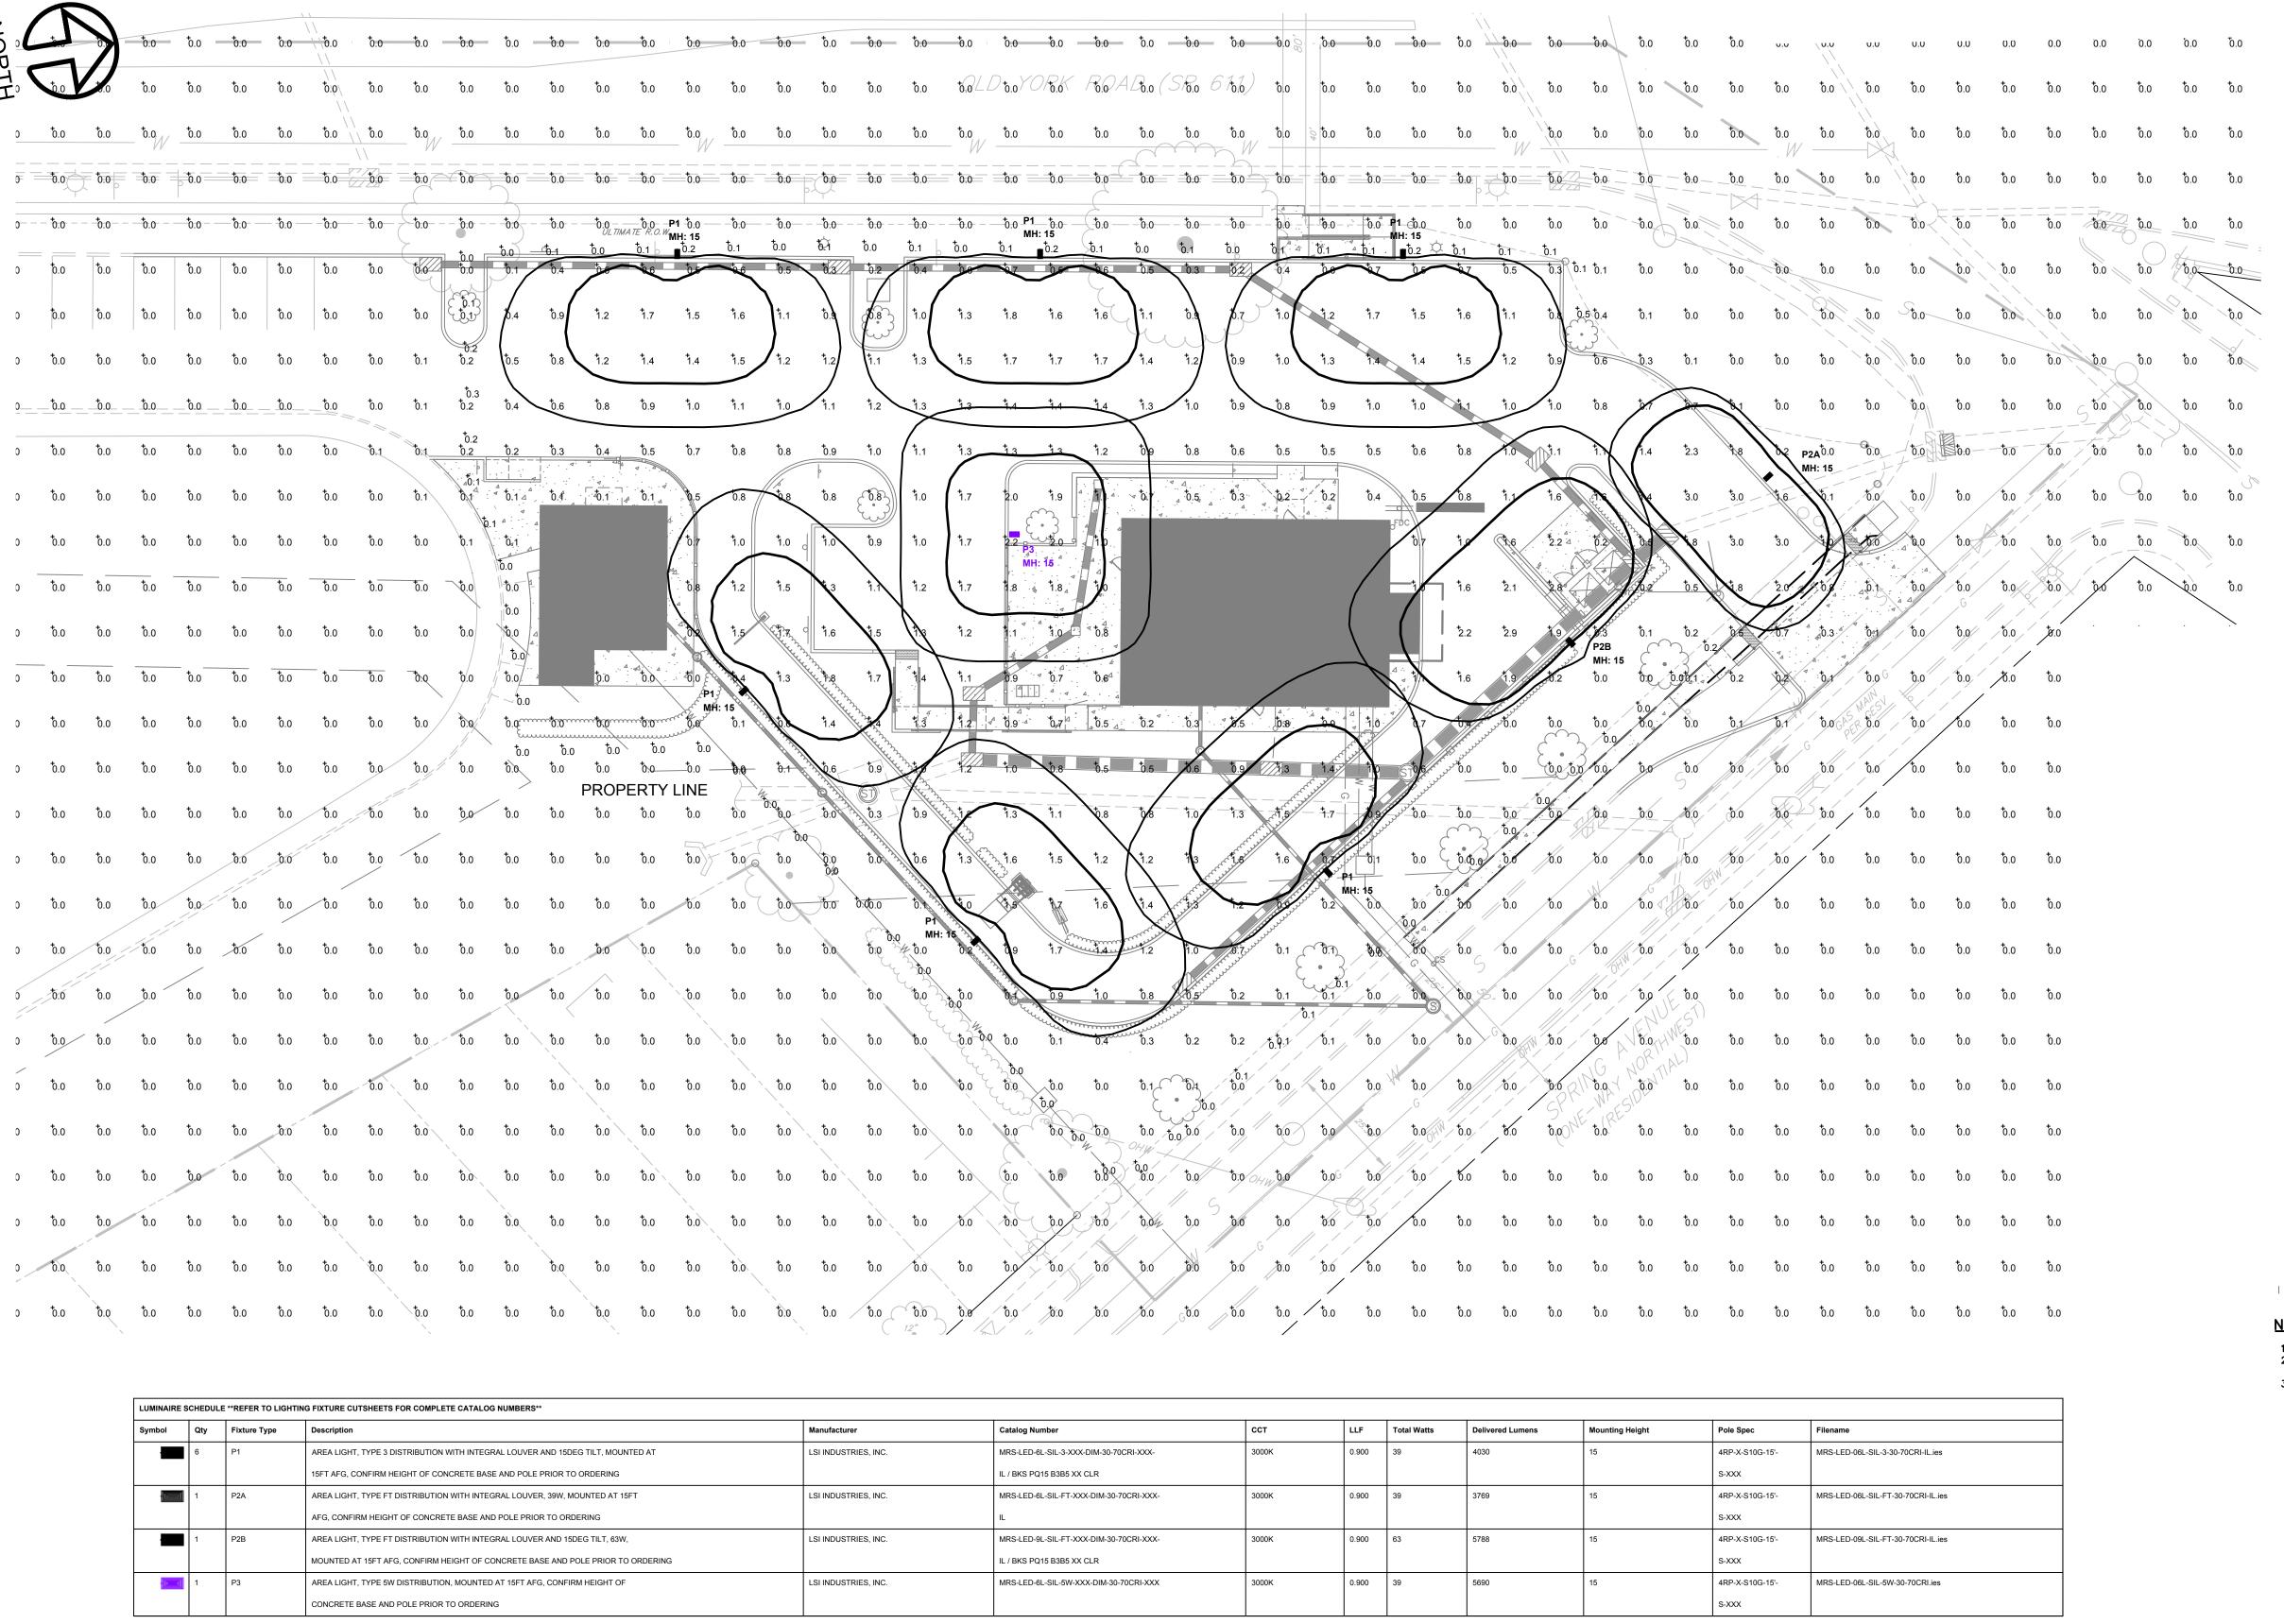

	LOCATION MAP  1" = 1,000'	JOHN L. KOUTSOUROS
LEGEND		PEOR7653 PEOR7653
	PARKING SETBACK LINE FROM	

200	
	_ PARKING SETBACK LINE .
	NONRESIDENTIAL
	— TOWNSHIP BOUNDARY
	— EXISTING ROAD CENTER I
w	— EXISTING WATER LINE
<i>S</i>	— EXISTING SEWER LINE
	= EXISTING STORM LINE
	= EXISTING CURB
	EXISTING SIGN
	= EXISTING CURB
	EXISTING SIGN
<b>\$</b>	EXISTING LIGHT POLE
	EXISTING WATER VALVE
	EXISTING INLET
$\bigcirc$	EXISTING UTILITY POLE
	EXISTING STORM MANHOL
	EXISTING SEWER MANHOL
	= PROPOSED CURB
·A · · · · · · · · · · · · · · · · · ·	PROPOSED CONCRETE
<u>A</u>	_ TROPOSED CONCRETE
	··· PROPOSED HEDGEROW
	PROPOSED SIGN
$\Diamond$	PROPOSED LIGHT POLE
( )	PROPOSED DECIDUOUS T
©	PROPOSED CLEANOUT


©	PROPOSED CLEANOUT
	PROPOSED SANITARY SEWER MANHOLE
	PROPOSED STORM SEWER MANHOLE
	PROPOSED SEWER PIPE
	PROPOSED TYPE "M" INLET
	PROPOSED TYPE "C" INLET
G	PROPOSED GAS LINE
W	PROPOSED DOMESTIC WATER LINE
——————————————————————————————————————	PROPOSED FIRE WATER LINE
<sub>o</sub> ps	PROPOSED DOWN SPOUT
cs	PROPOSED CURB STOP

PROPOSED FIRE DEPARTMENT CONNECTOR

## NOTES:

- 1. MH: IS THE LIGHTING FIXTURE MOUNTING HEIGHT 2. REFLECTANCES OF 80/50/20 ARE USED UNLESS OTHERWISE NOTED (FOR INTERIOR CALCULATIONS)
- 3. CALCULATION POINTS ON THE WORKPLANE ARE AT 2.5' (INTERIOR) OR GROUND AT 0.0' (EXTERIOR) UNLESS OTHERWISE NOTED

CALCULATION SUMMARY	CALCULATION SUMMARY														
Label	СаісТуре	Units	Avg	Max	Min	Avg/Min	Max/Min	PtSpcLr	PtSpcTb						
CalcPts to Zero	Illuminance	Fc	0.2	3.0	0.0	N.A.	N.A.	10	10						
PROPERTY LINE	Illuminance	Fc	0.1	0.5	0.0	N.A.	N.A.	10	N.A.						
StatArea_DRIVE ENTRY	Illuminance	Fc	2.0	3.0	0.7	2.9	4.3								
StatArea_DRIVE-THRU	Illuminance	Fc	1.0	2.2	0.3	3.4	7.3								
StatArea_PARKING LOT	Illuminance	Fc	1.0	3.0	0.2	5.2	15.0								

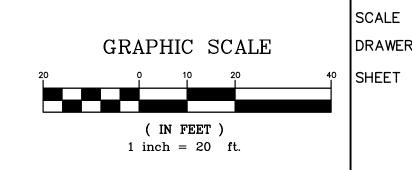

DATE 6/19/2023 CADD FILE 2211190112 JOB NO 221119 DSG BY CML CML DWN BY JLK

 $\mathbf{\omega}$ 


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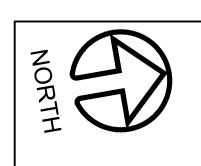
CKD BY SCALE DRAWER NUMBER


\_ OF 16 SHEETS


DRAWING NUMBER LL-102

1" = 20'



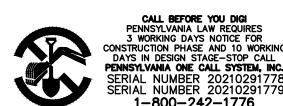

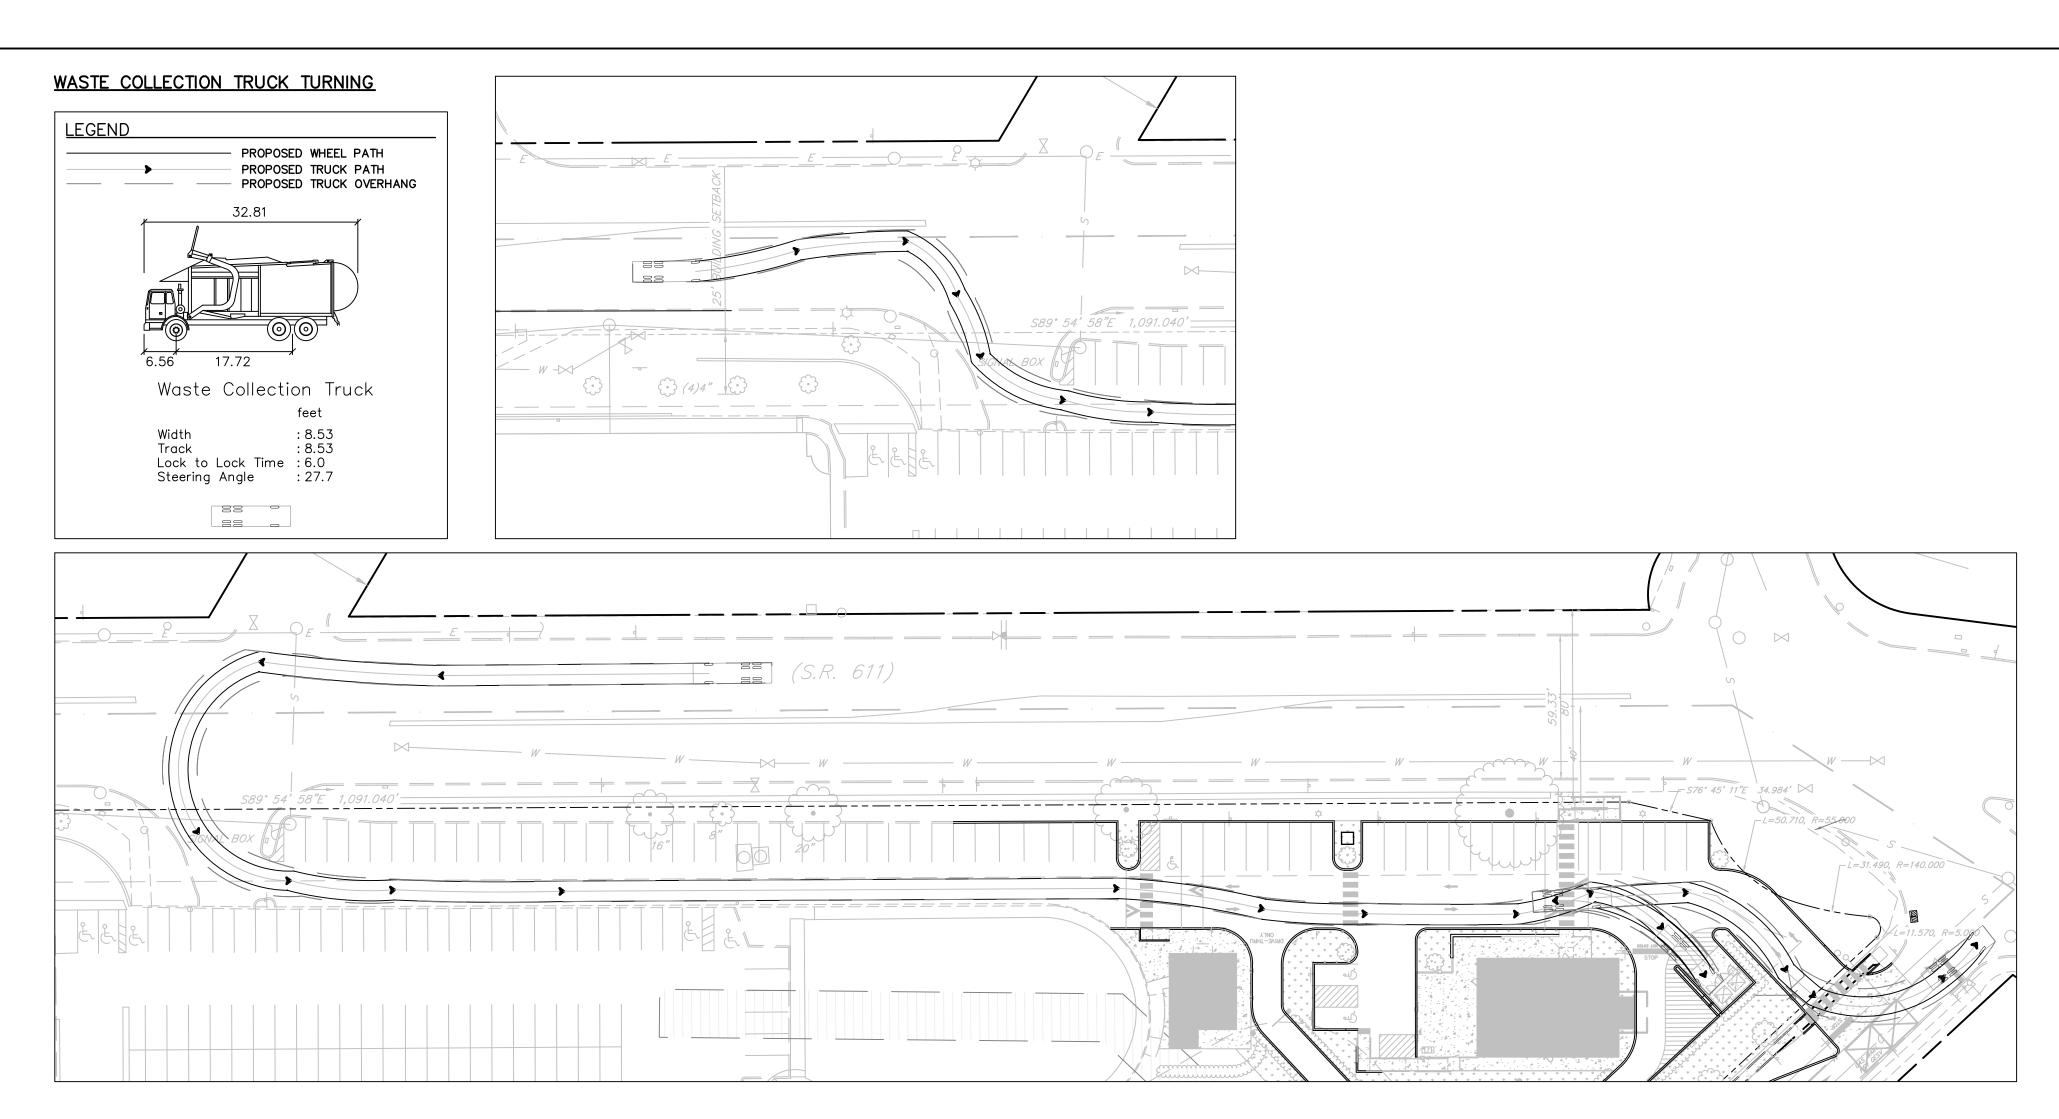

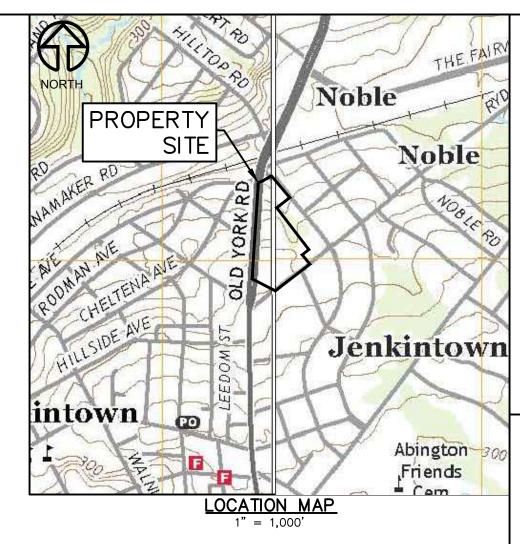

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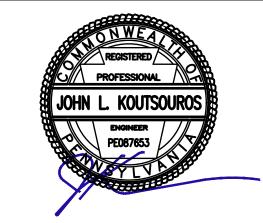
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ROAD

6/19/2023 2211190116

221119

CADD FILE

DWN BY CKD BY SCALE

GRAPHIC SCALE

( IN FEET )

1 inch = 40 ft.

DRAWER NUMBER

CML
CML
JLK
1" = 40' SHEET <u>15</u>

OF 16 SHEETS DRAWING NUMBER C - 104

